Appendix M Draft Conceptual Plan Submission

EPT CONCORD RESORT - PHASE 1

TOWN OF THOMPSON, SULLIVAN COUNTY, NY

DRAFT CONCEPTUAL PLAN SUBMISSION

CLIENT/OWNER:

ENTERTAINMENT PROPERTIES TRUST 909 WALNUT, SUITE 200 KANSAS CITY, MO 64106 (816) 472-1700 (PHONE) (816) 472-5794 (FAX)

HART HOWERTON 10 EAST 40TH STREET NEW YORK, NY 10016 (212) 683-5631 (PHONE) (212) 481-3768 (FAX)

CIVIL & ENVIRONMENTAL ENGINEER:

CAKRF

AKRF ENGINEERING, P.C. 34 SOUTH BROADWAY, SUITE 401 WHITE PLAINS, NY 10601 (914) 949-7336 (PHONE) (914) 949-7559 (FAX)

INDEX OF DRAWINGS

COVER SHEET AND INDEX OF DRAWINGS

C-101 OVERALL SITE PLAN

C-200 OVERALL EXISTING CONDITIONS PLAN
C-401 - C-407 SITE GEOMETRY PLAN - TILES 1 TO 7

C-501 - C-507 PAVING, GRADING AND DRAINAGE - TILES 1 TO 7

C-601 - C-608 COMPOSITE UTILITY PLAN - TILES 1 TO 8


C-701 - C-707 EROSION AND SEDIMENT CONTROL PLAN - TILES 1 TO 7

C-800 - C-805 SITE DETAILS

PROPOSED MONTICELLO RACEWAY
MANAGEMENT, INC. ("MRMI") RESORT
CASINO AND HARNESS HORSE RACE
TRACK PROJECT LOCATION—





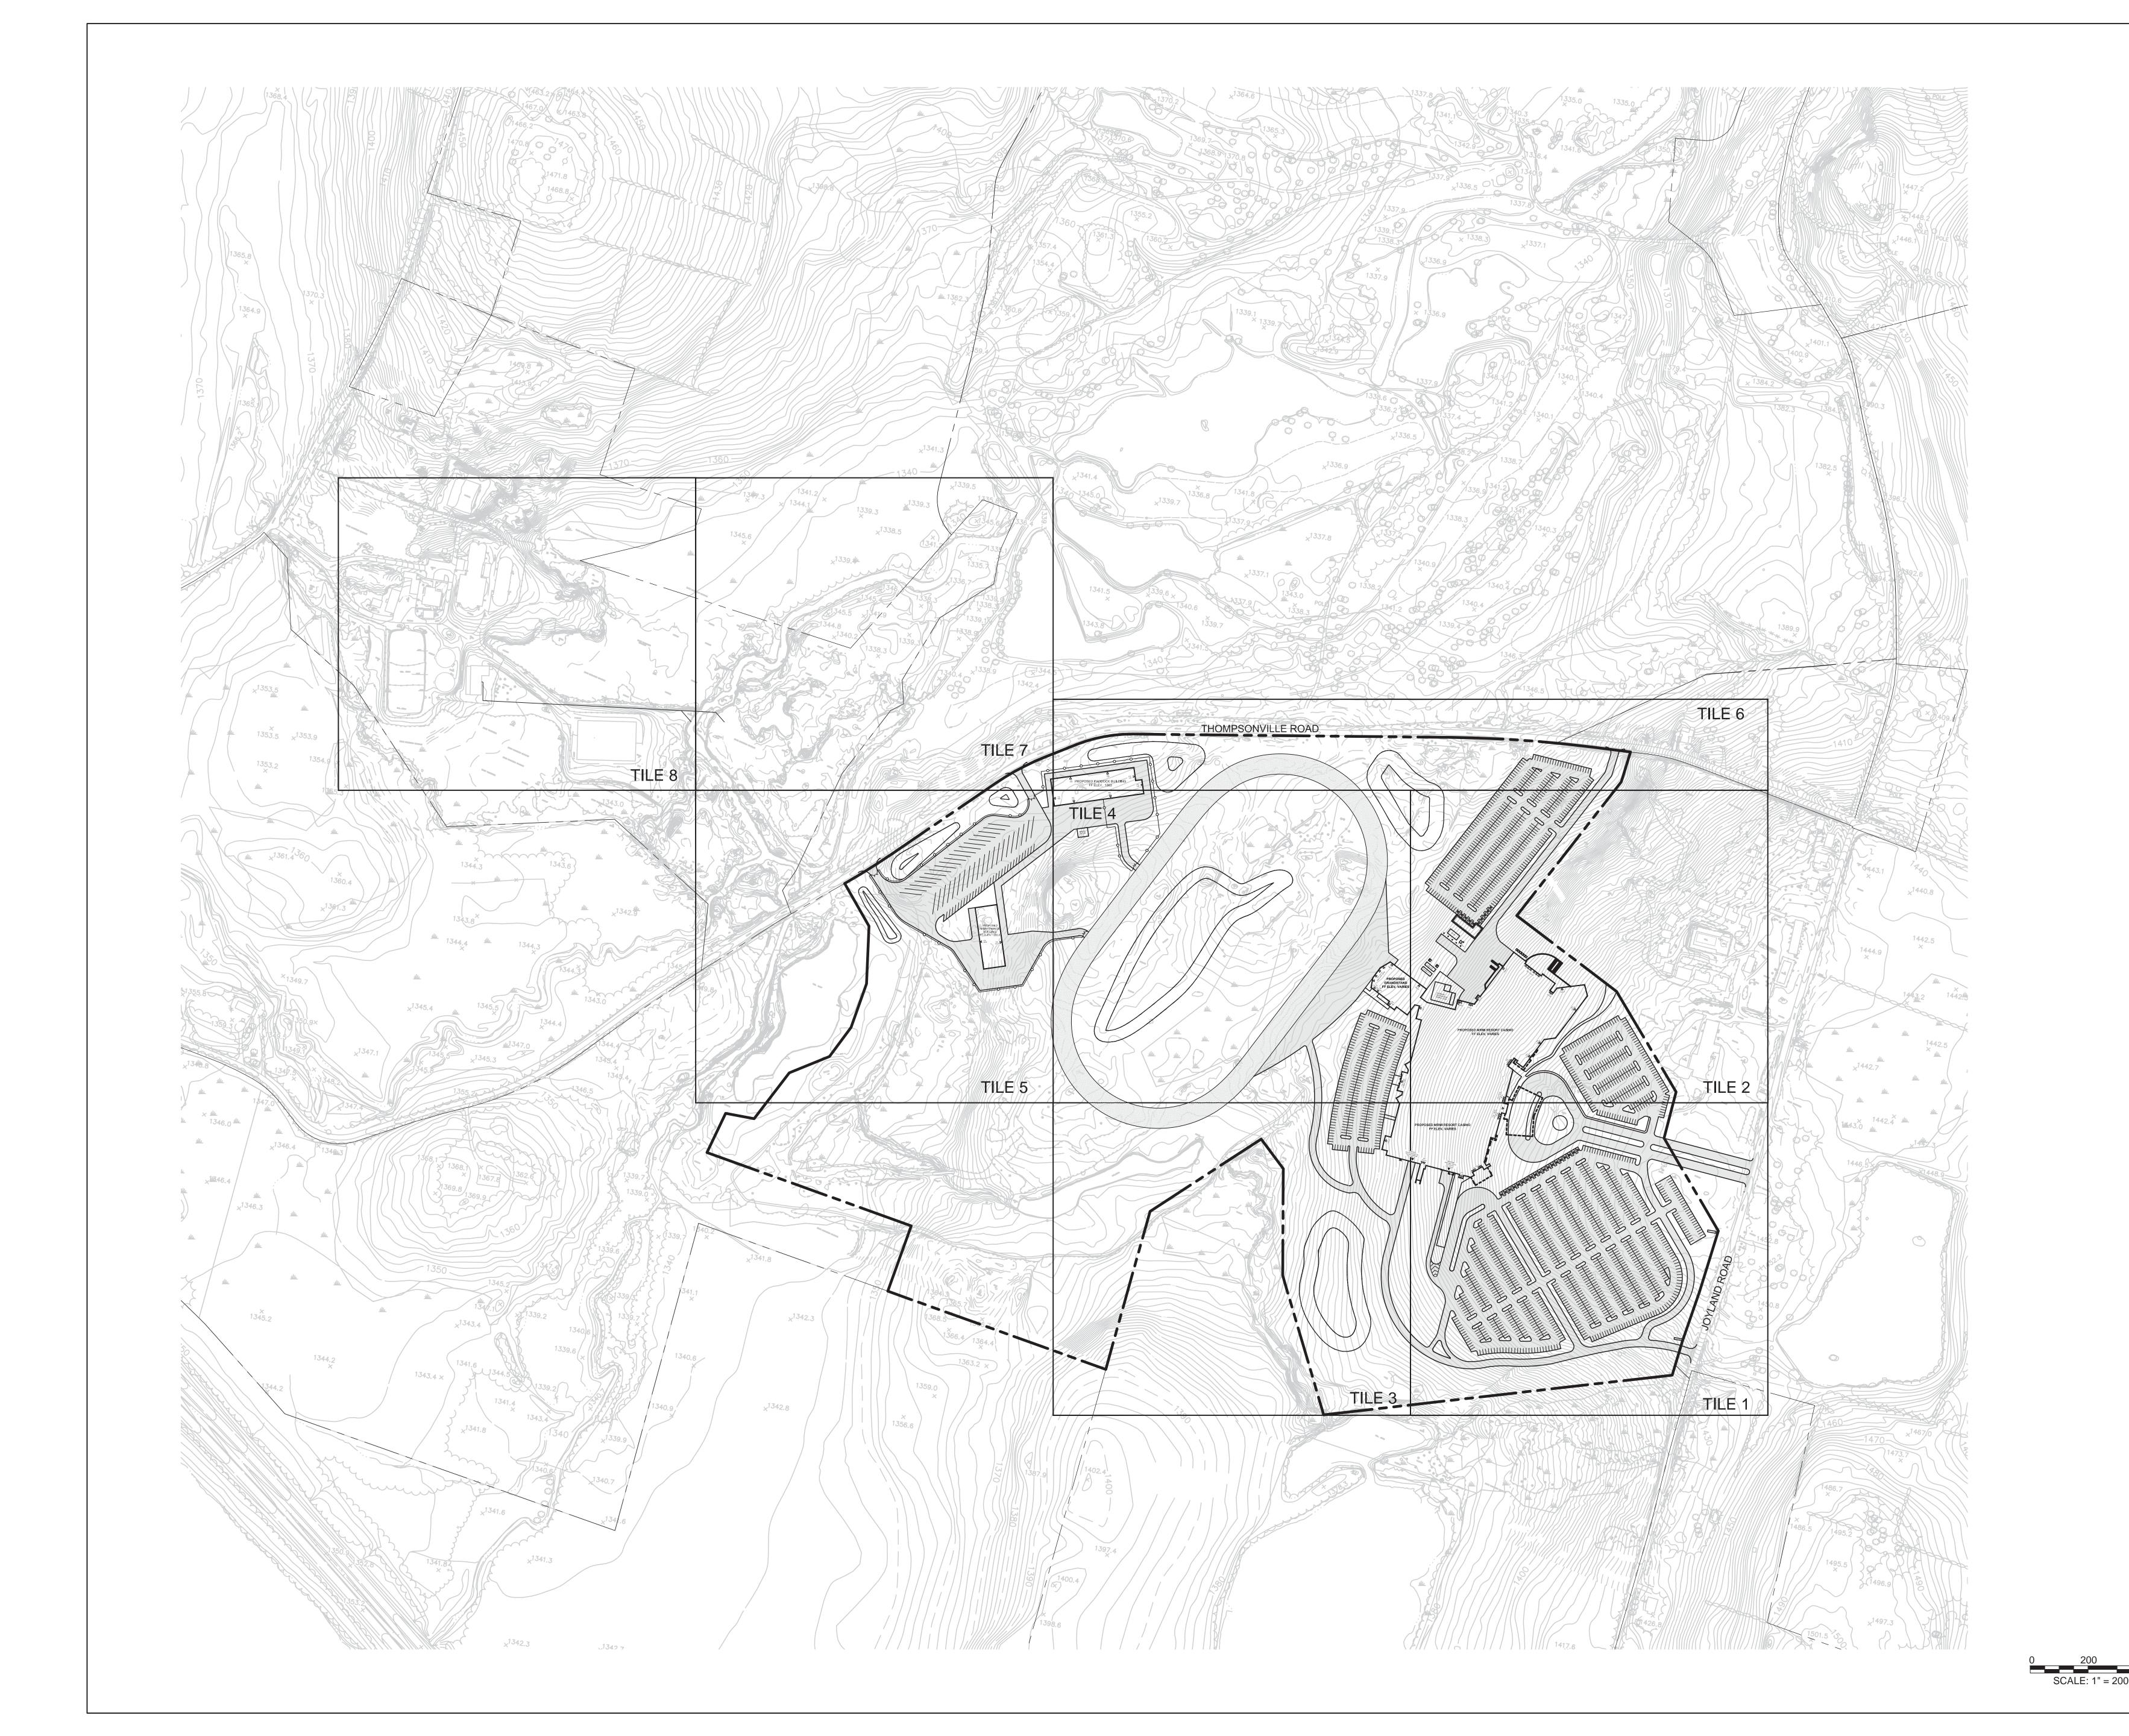

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CONTRACTORS' LINE & GRADE SOUTH, LLC

23 NEPPERHAN AVENUE ELMSFORD, NY 10523 (914) 347-3141 (PHONE) (914) 347-3120 (FAX)

GEOTECHNICAL CONSULTANT

MELICK-TULLY AND ASSOCIATES, P.C. 117 CANAL ROAD SOUTH BOUND BROOK, NJ 08880

(732) 356-3400 (PHONE) (732) 356-9054 (FAX)

PROGRESS SET NOT FOR CONSTRUCTION

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REVISIONS

No. DATE DESCRIPTION

PROJECT
EPT CONCORD RESORT
PHASE 1
TOWN OF THOMPSON
NEW YORK

DRAWN BY
JH, MH, DM, JT

SCALE
1"=200'

CHECKED BY
AM, KF, JM


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06/08/12


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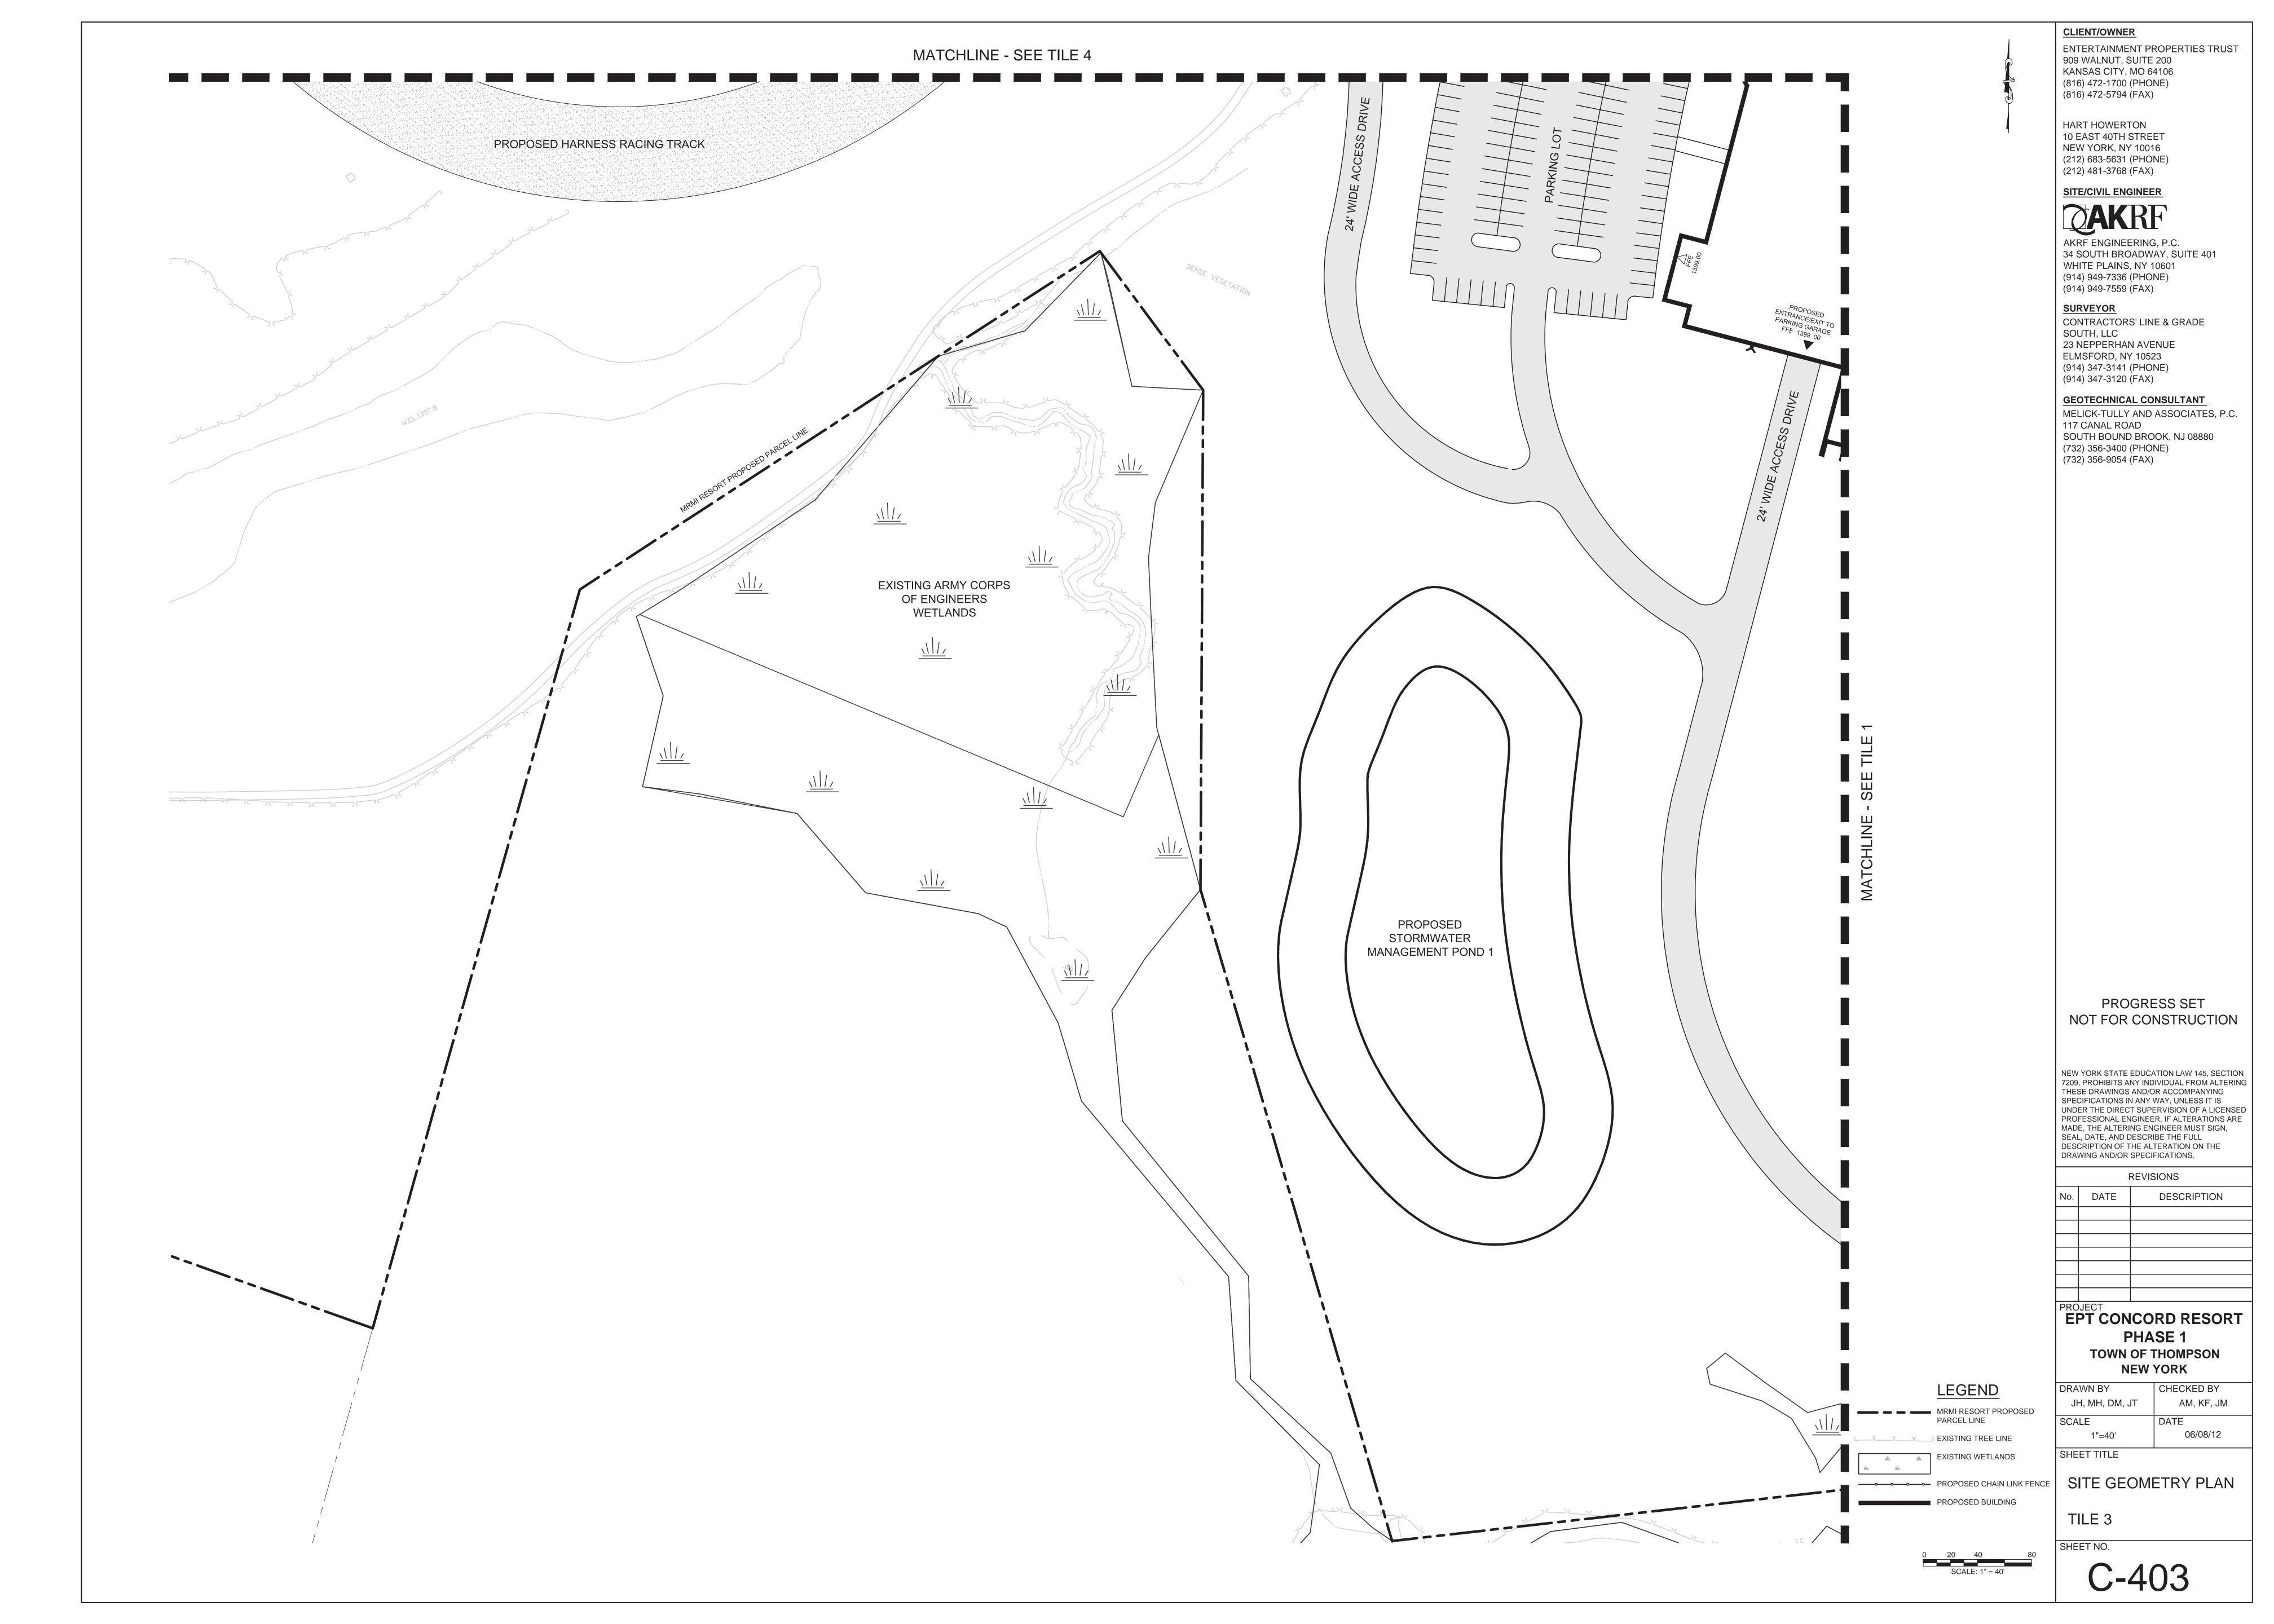
SHEET NO.


OVERALL SITE PLAN







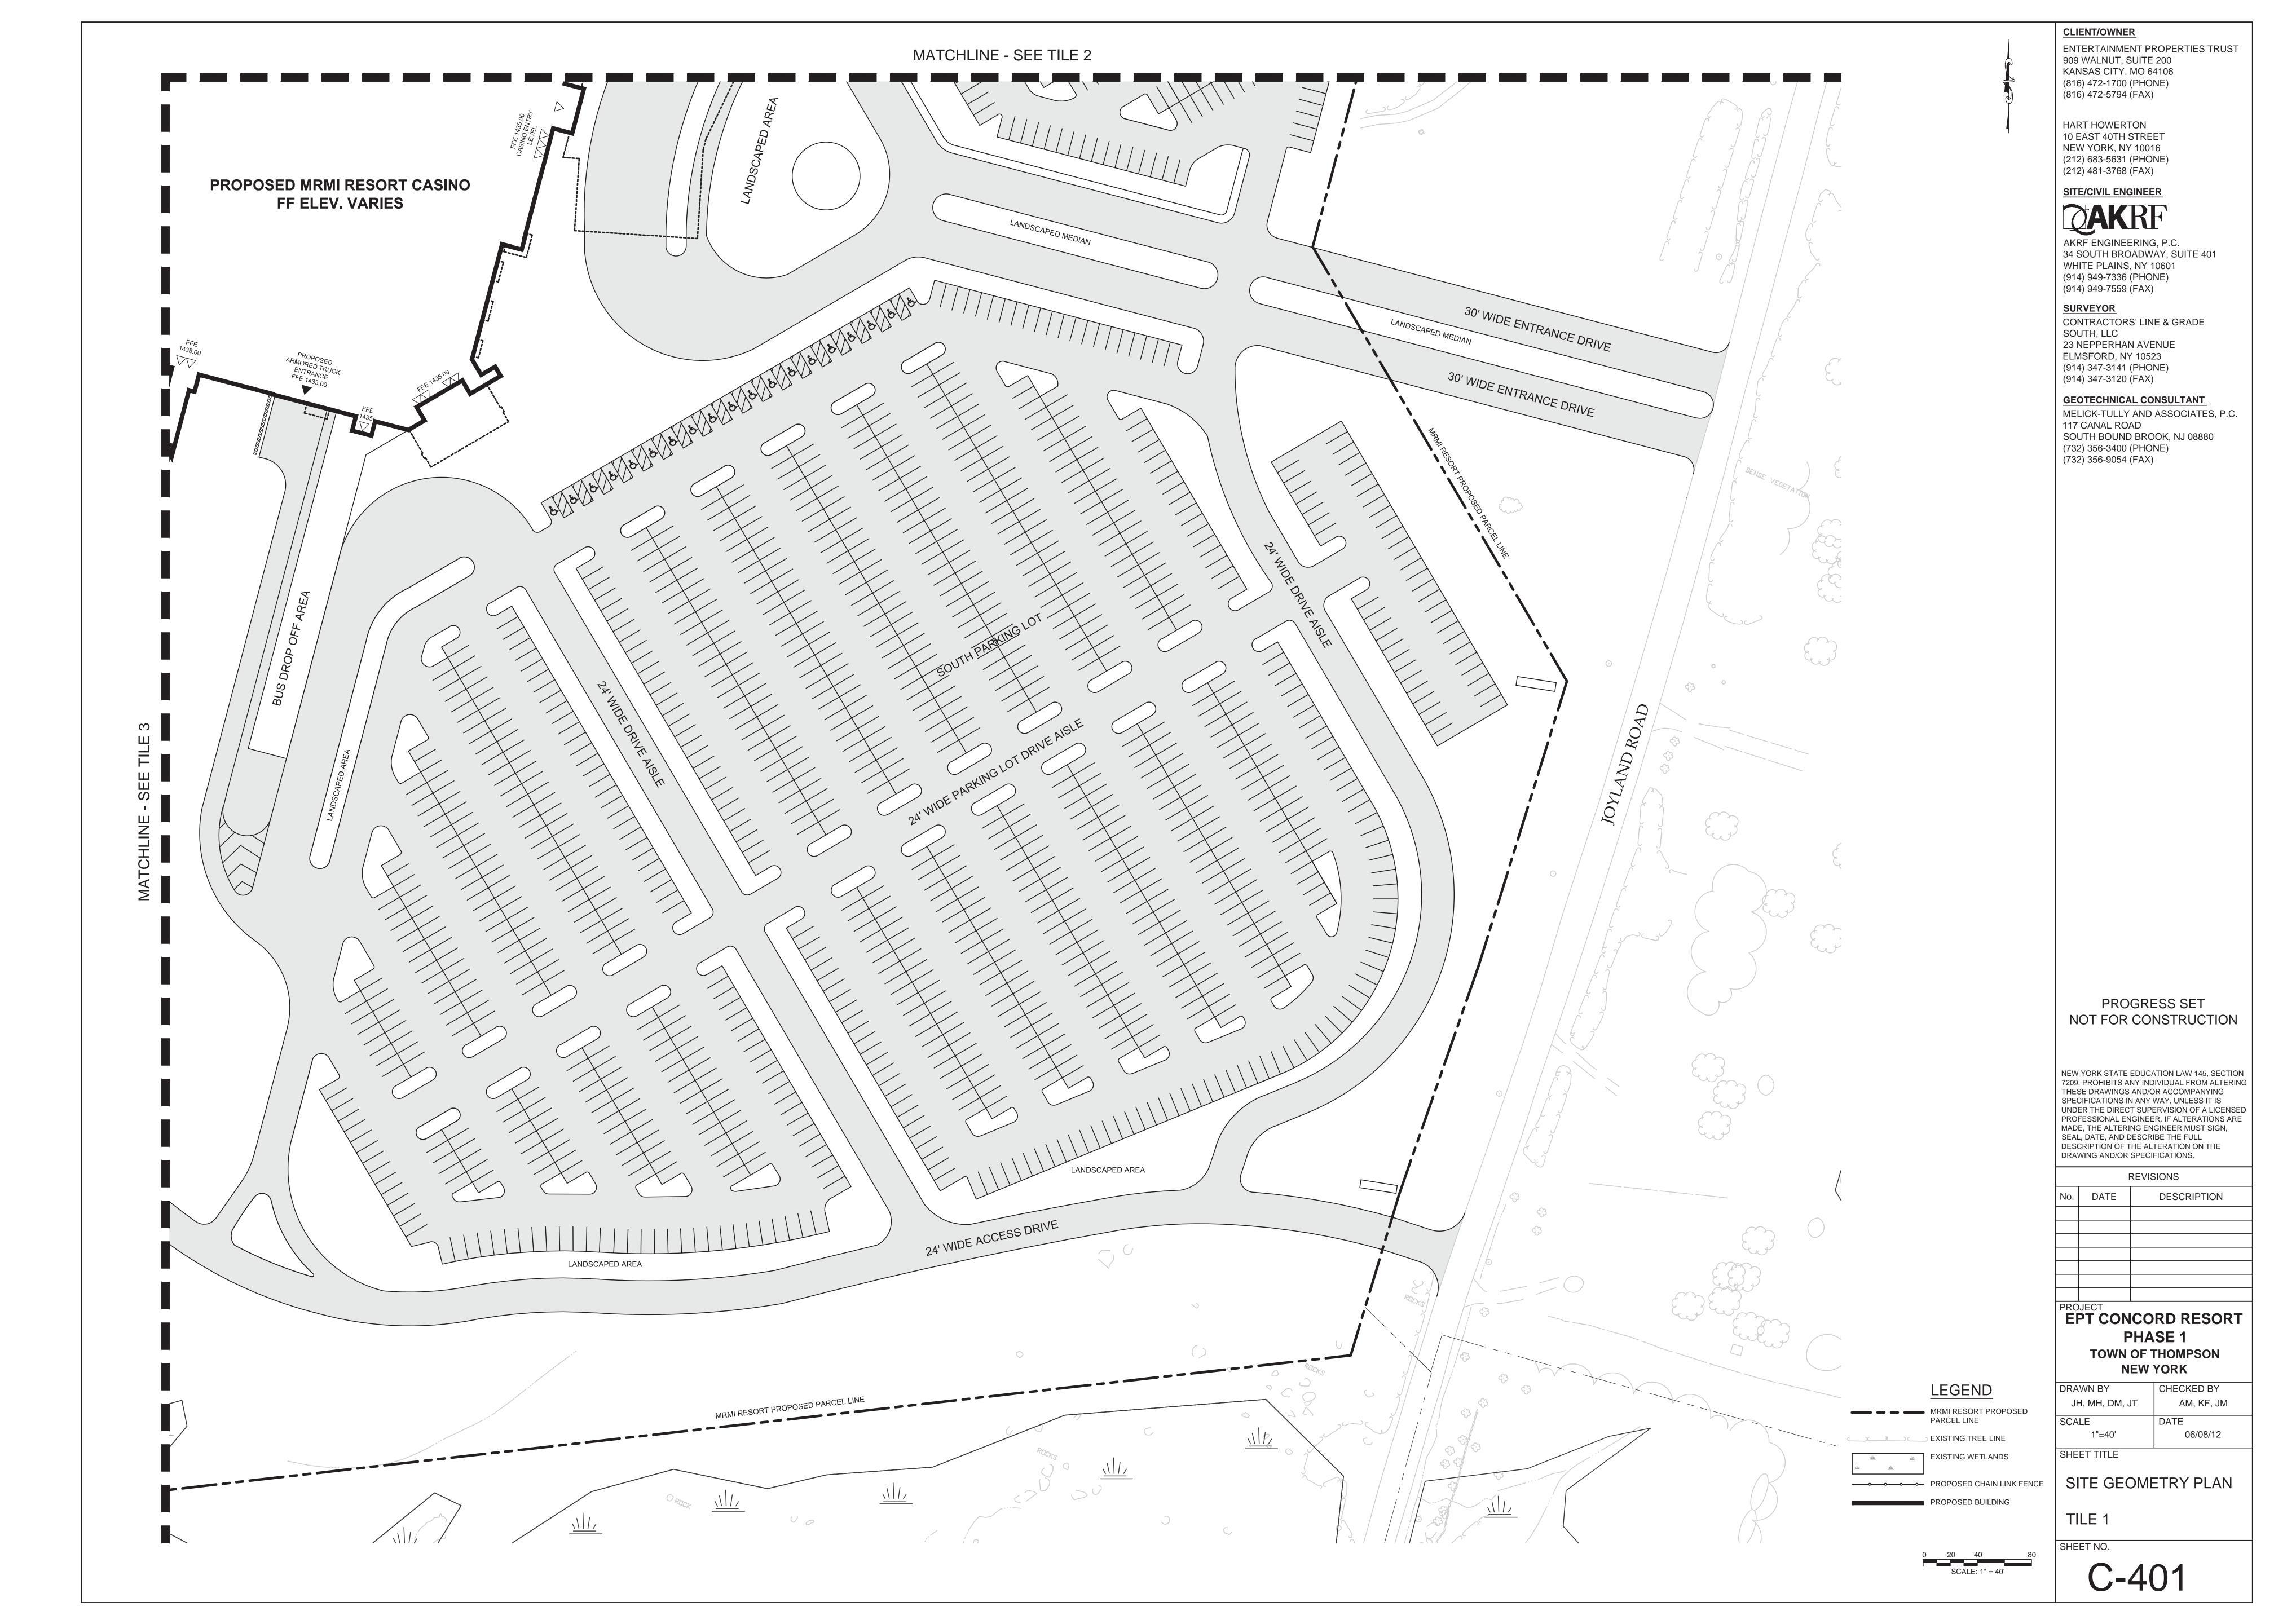

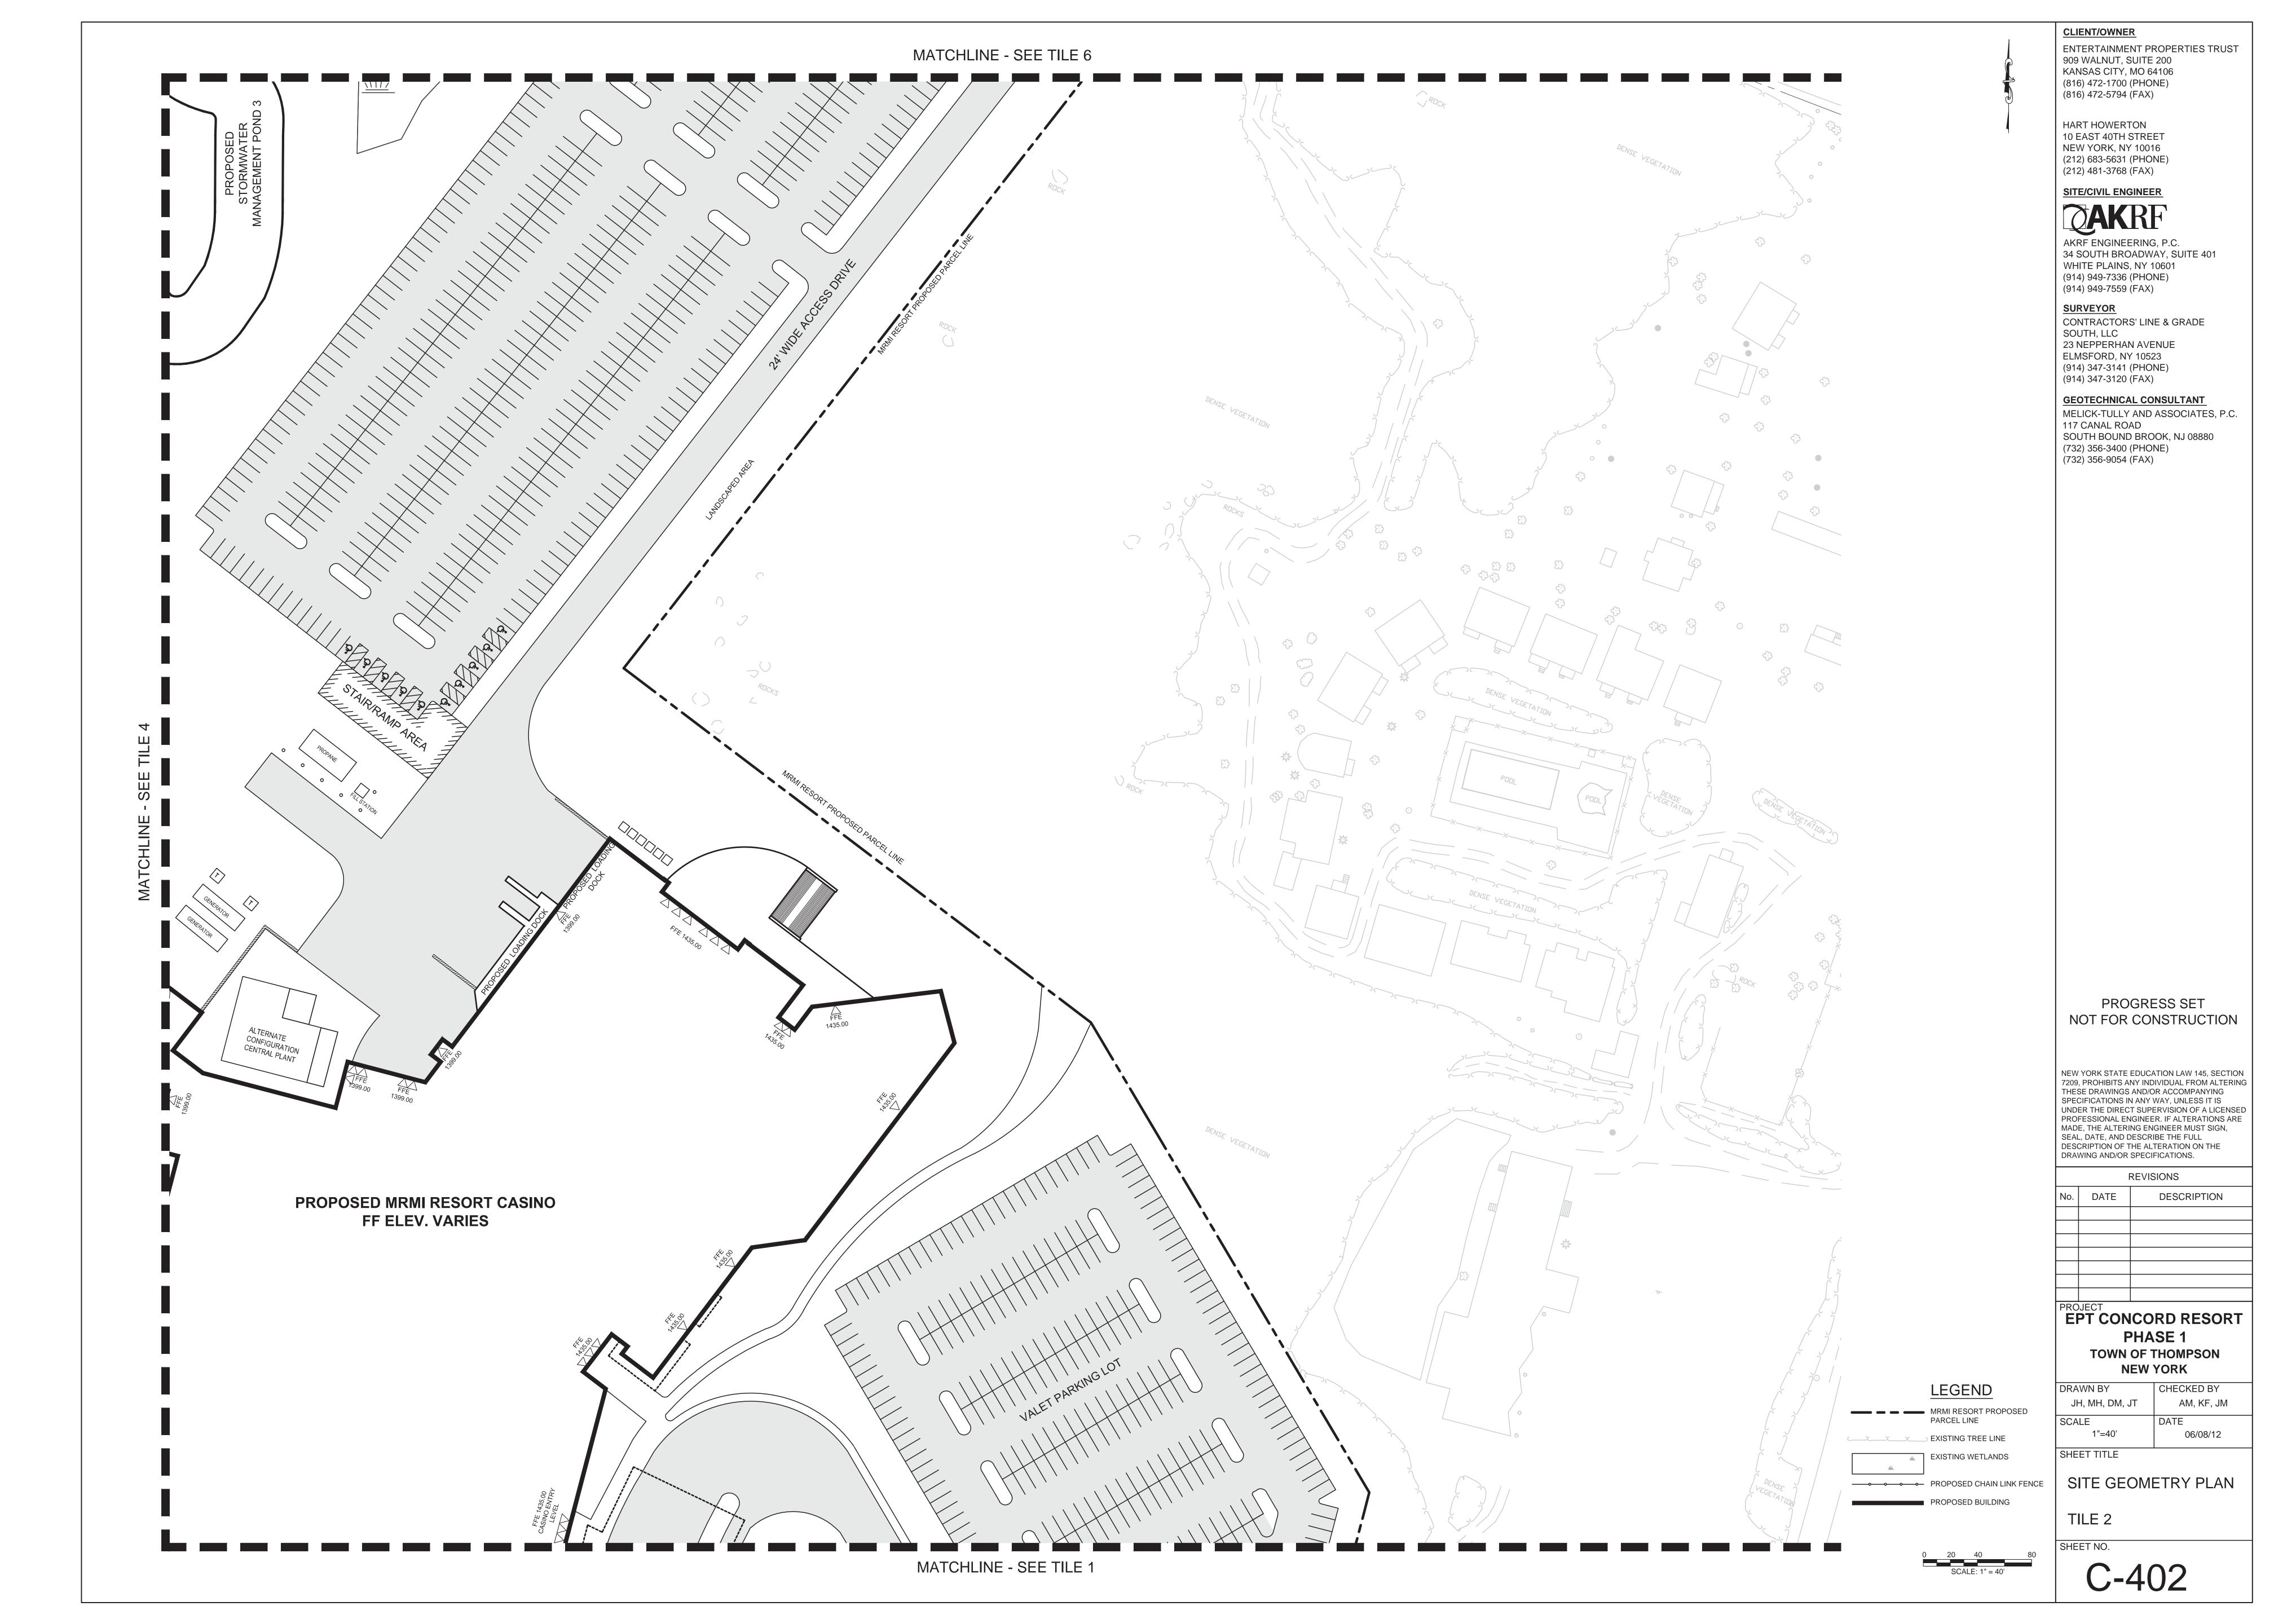


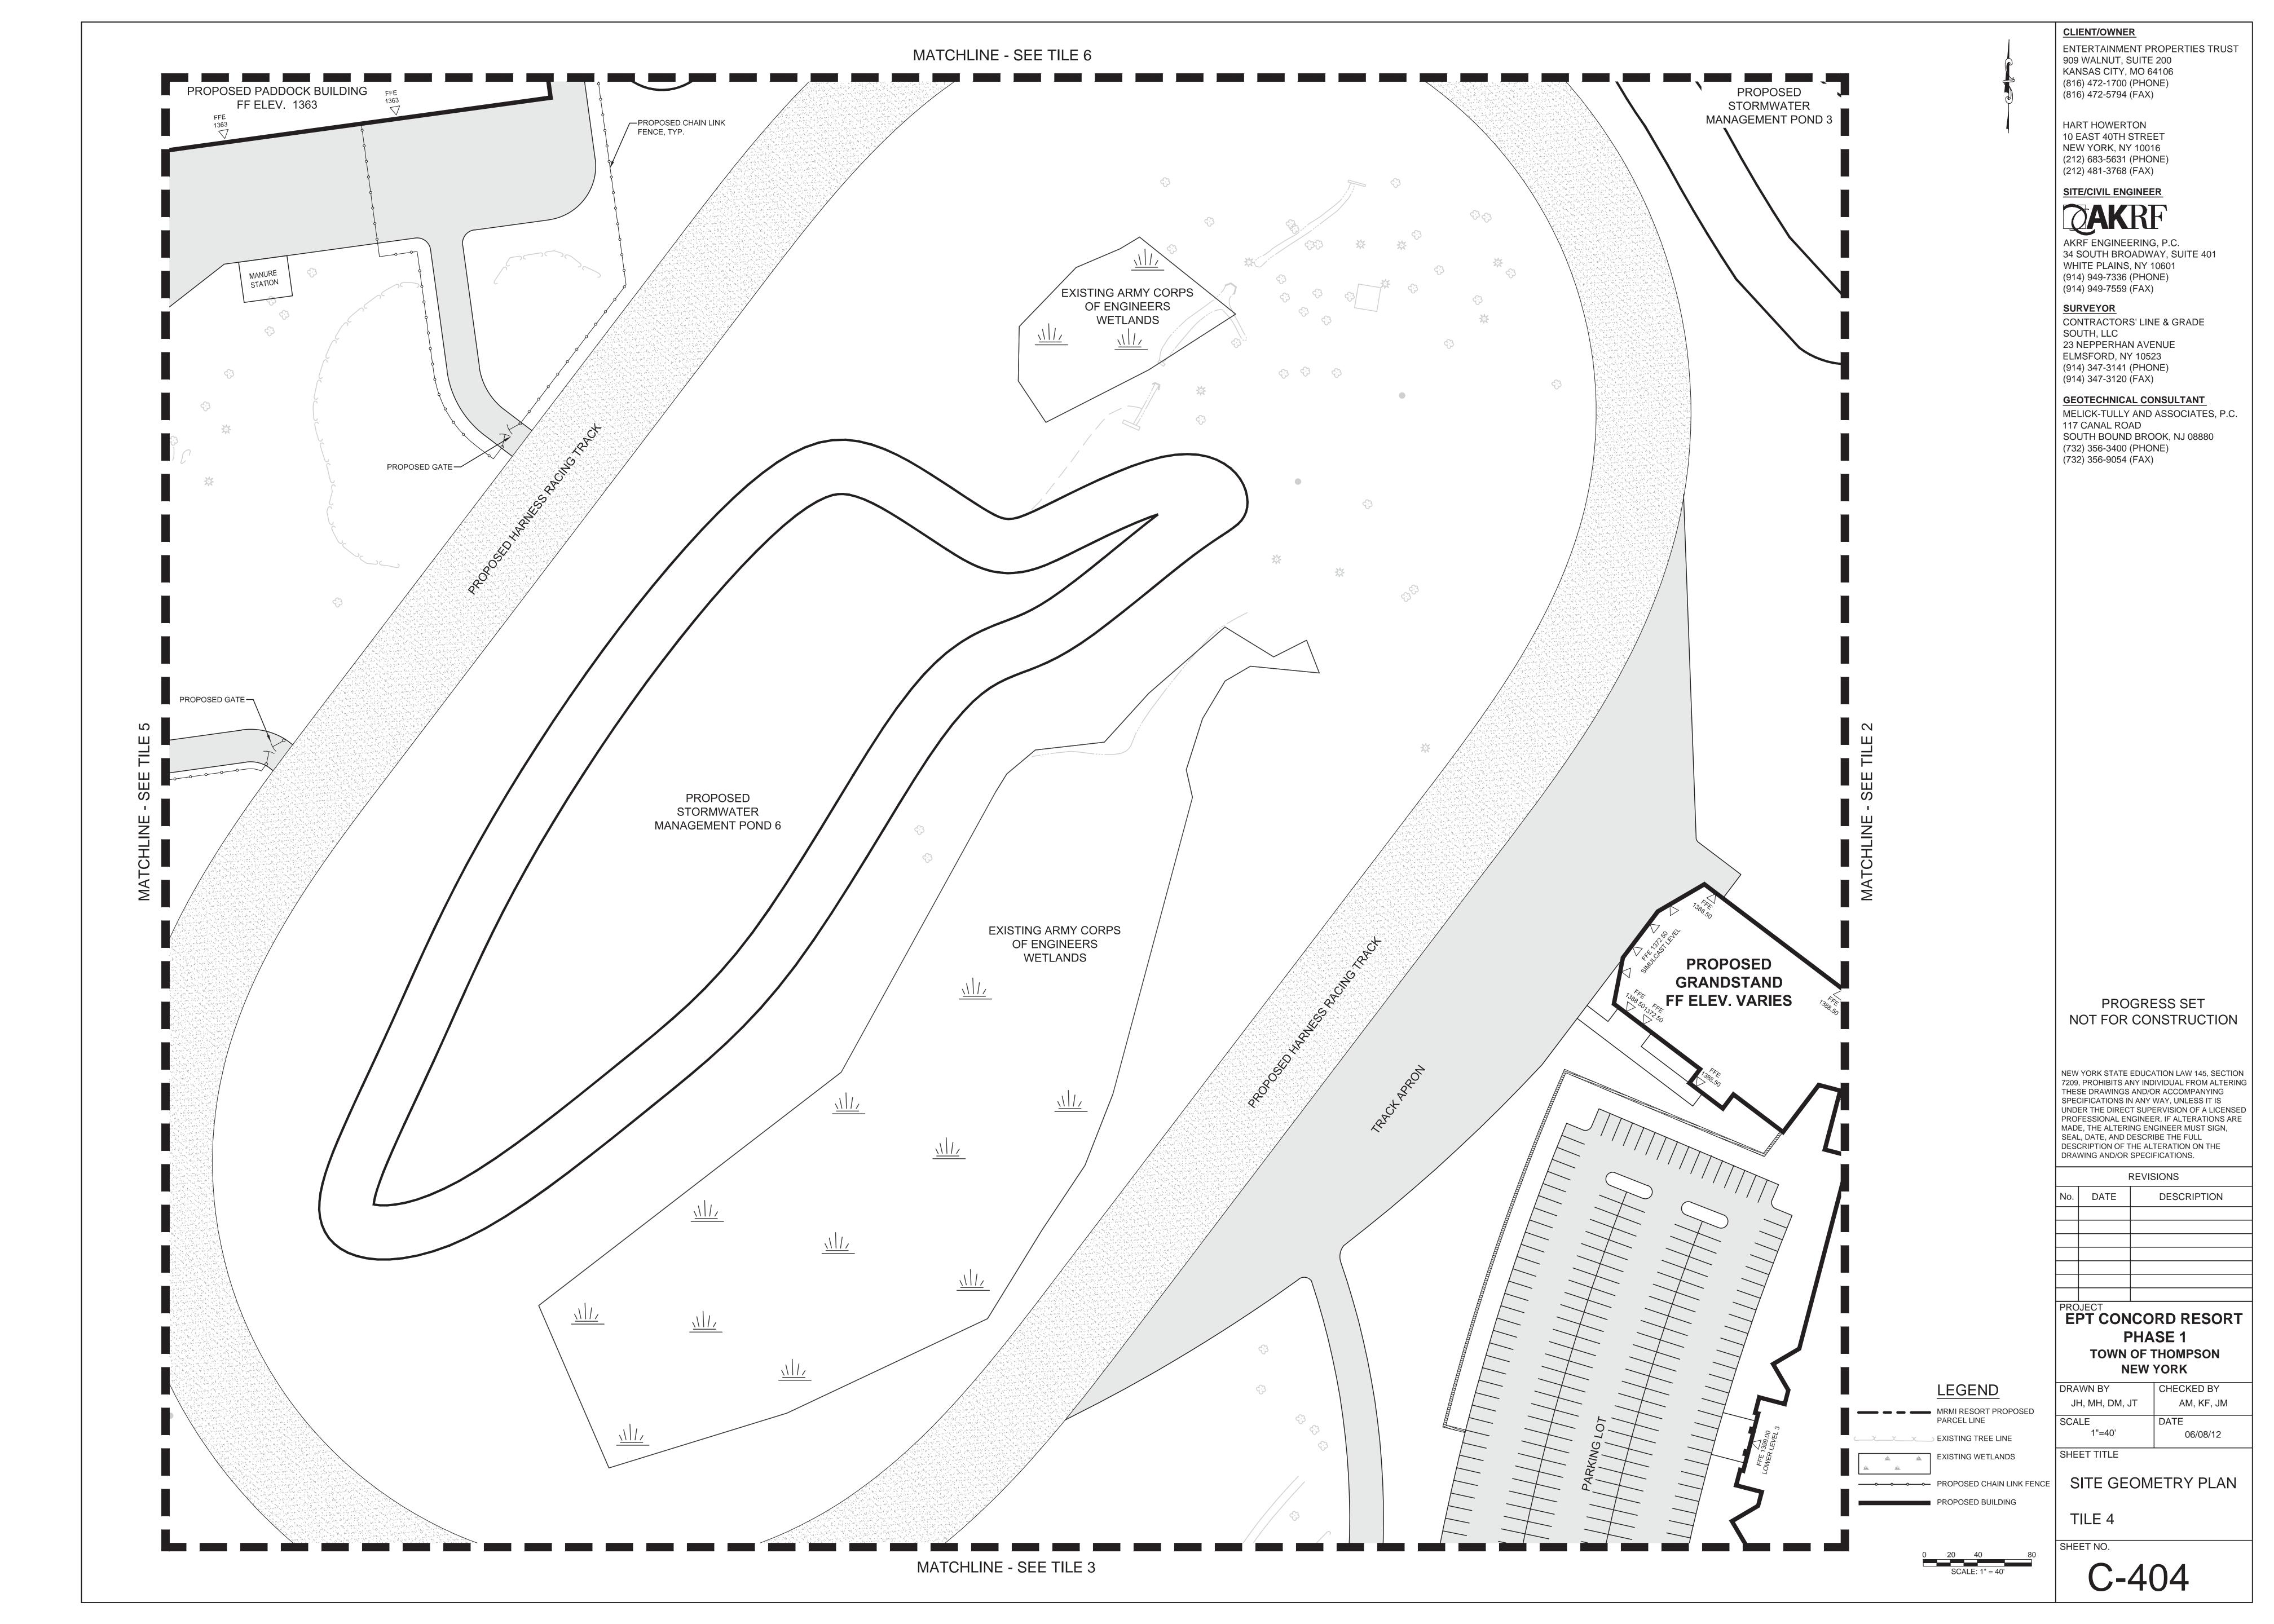

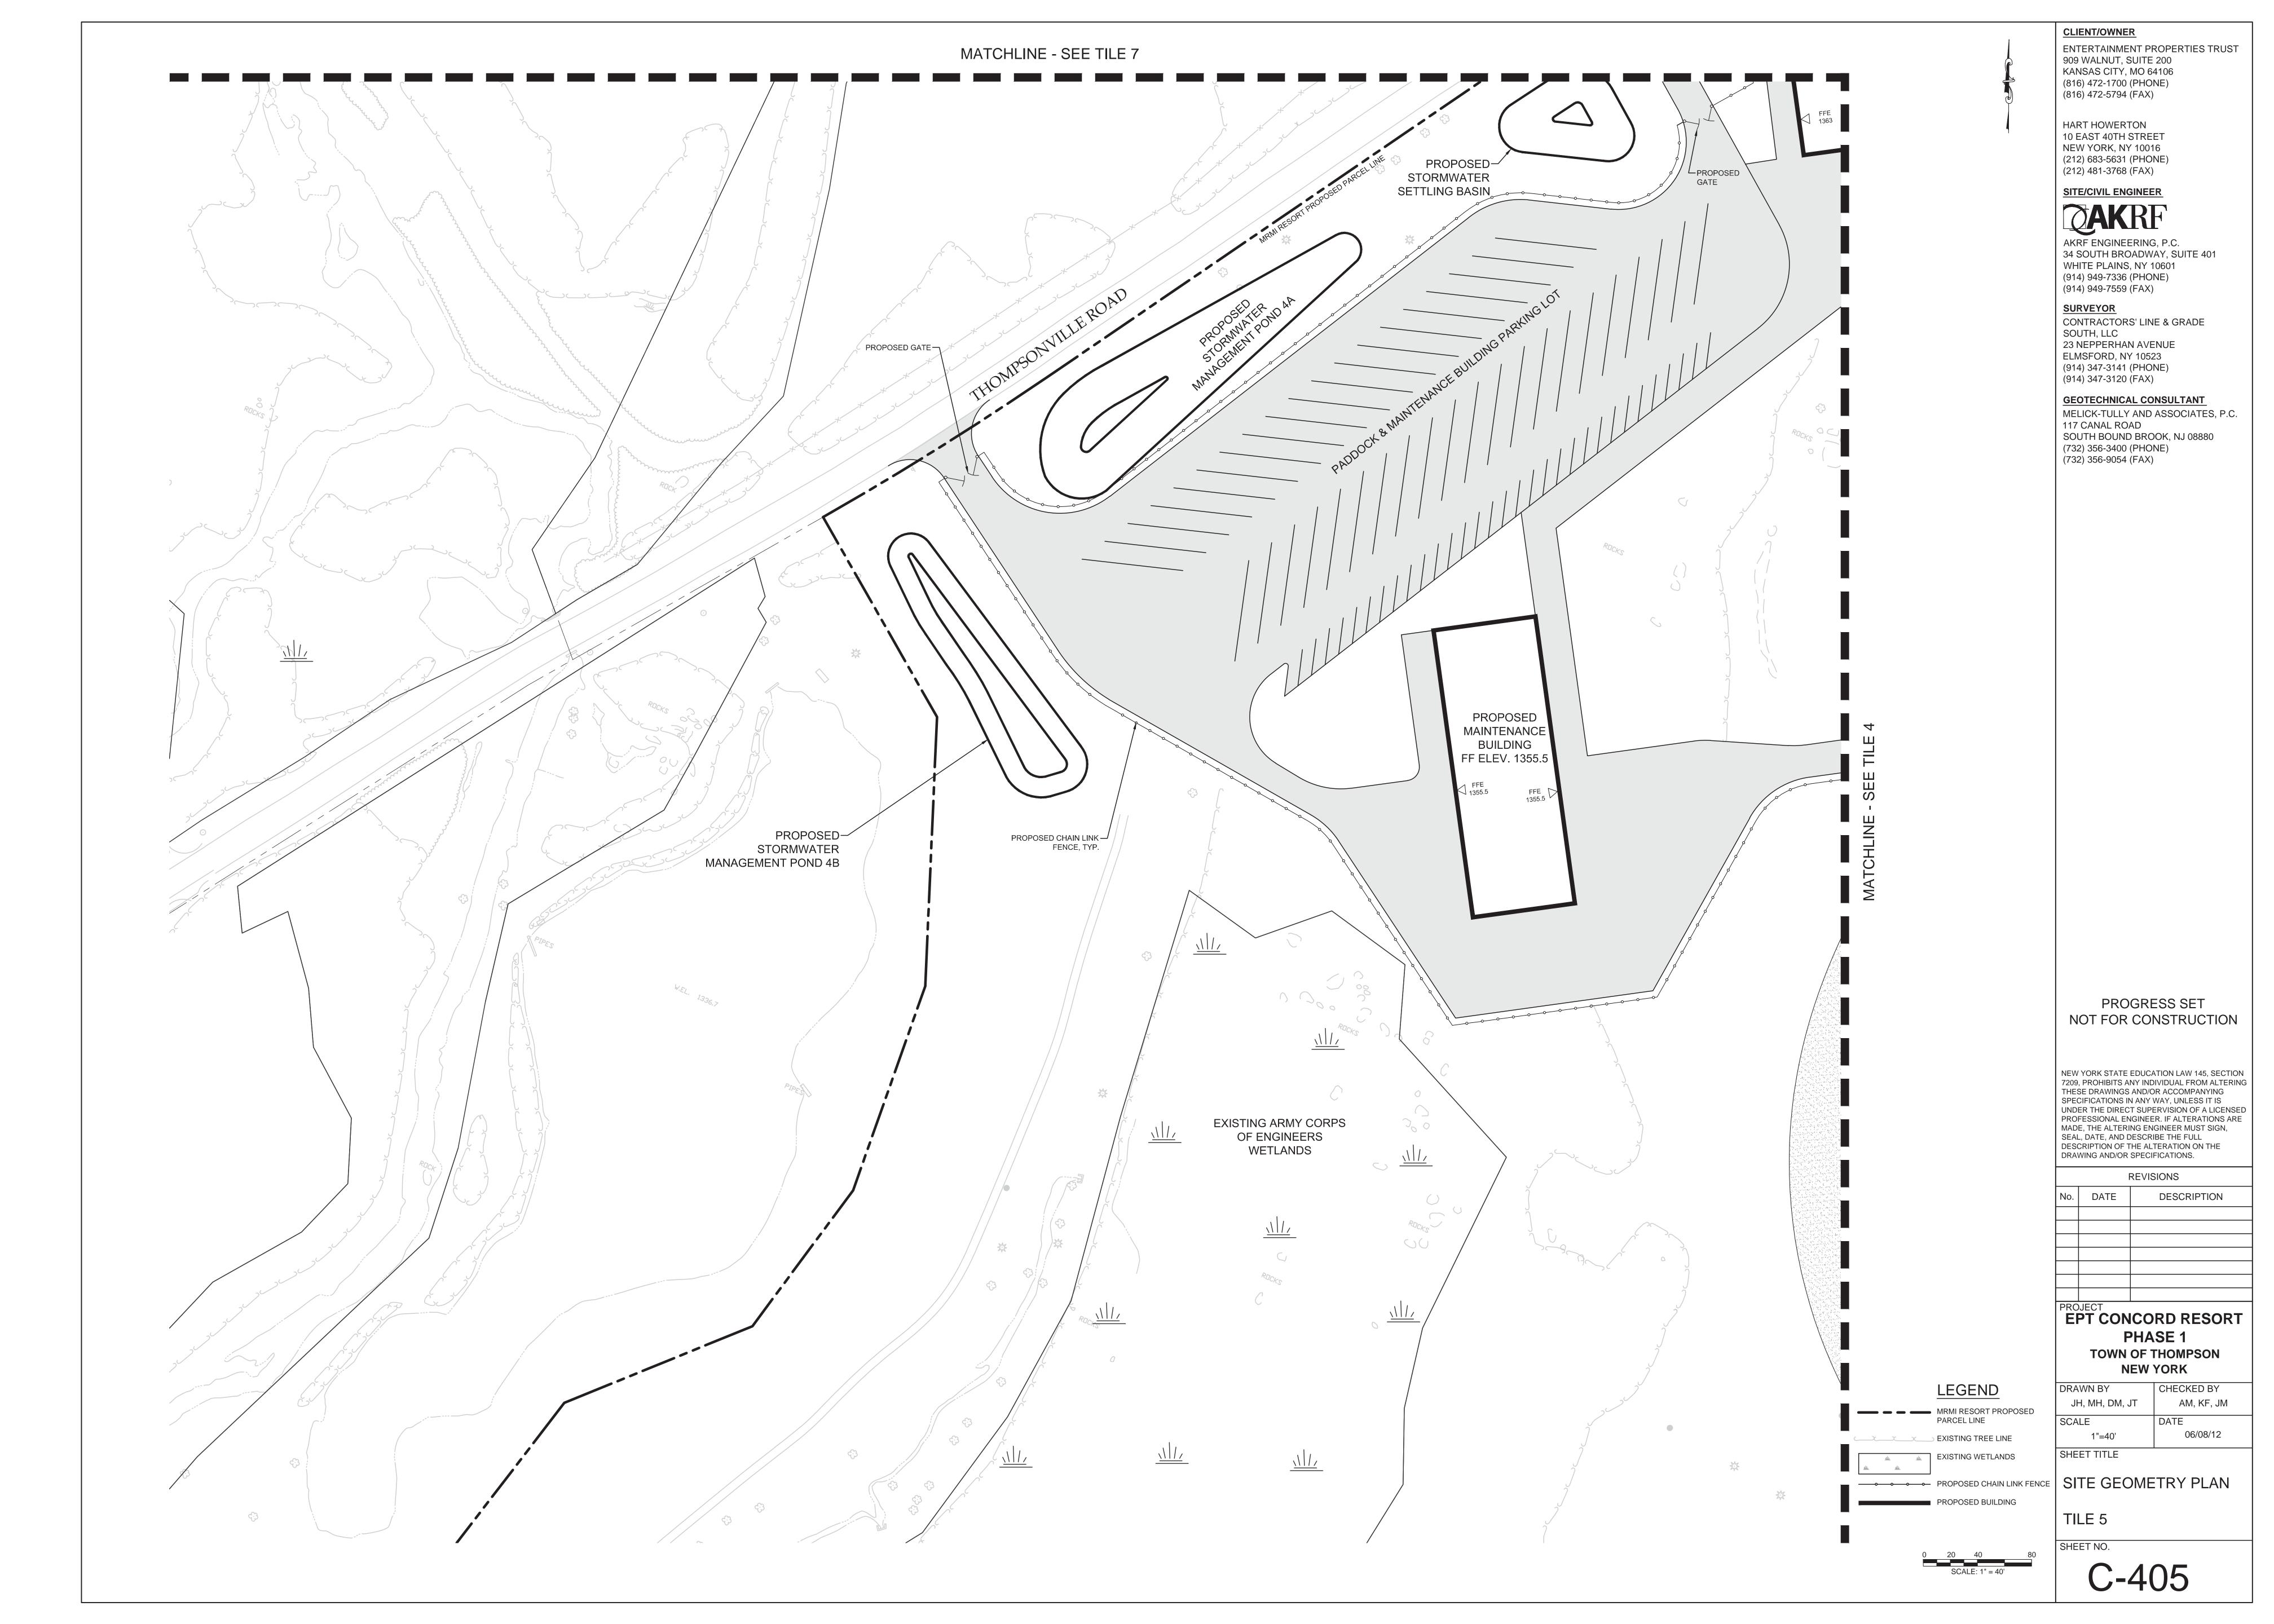

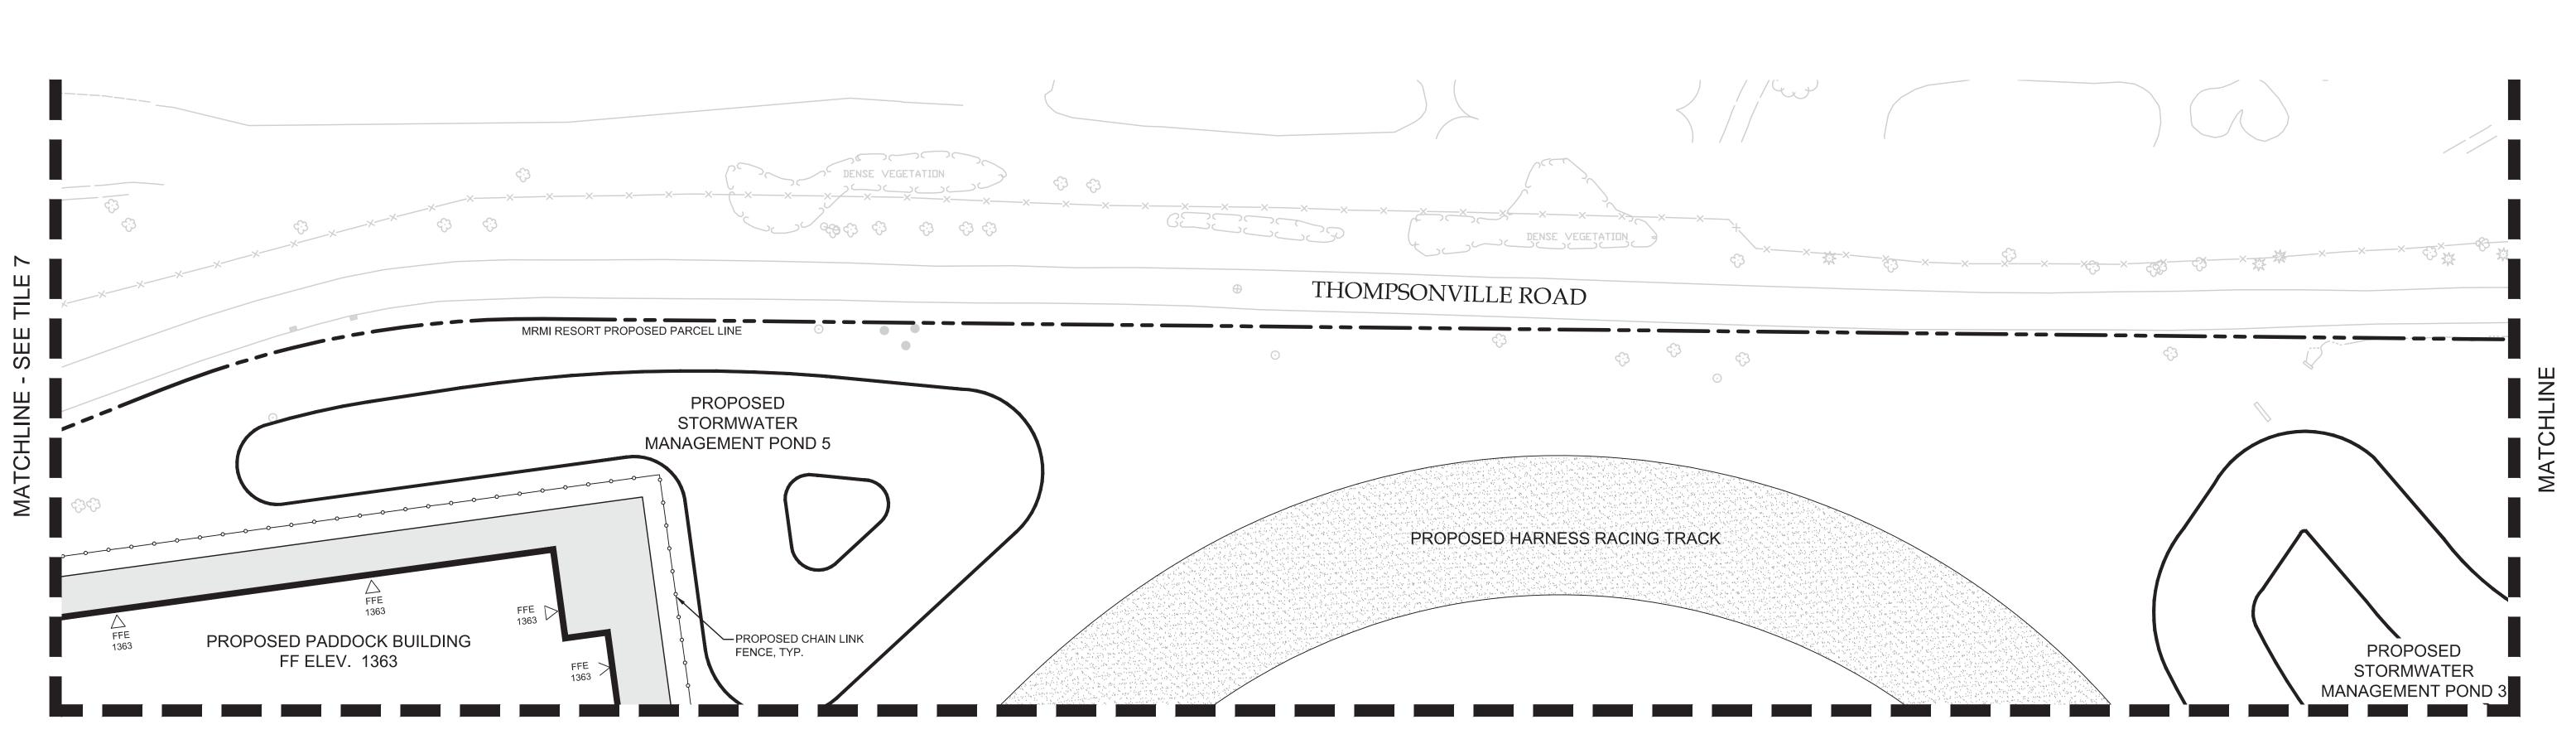

MATCHLINE - SEE TILE 4

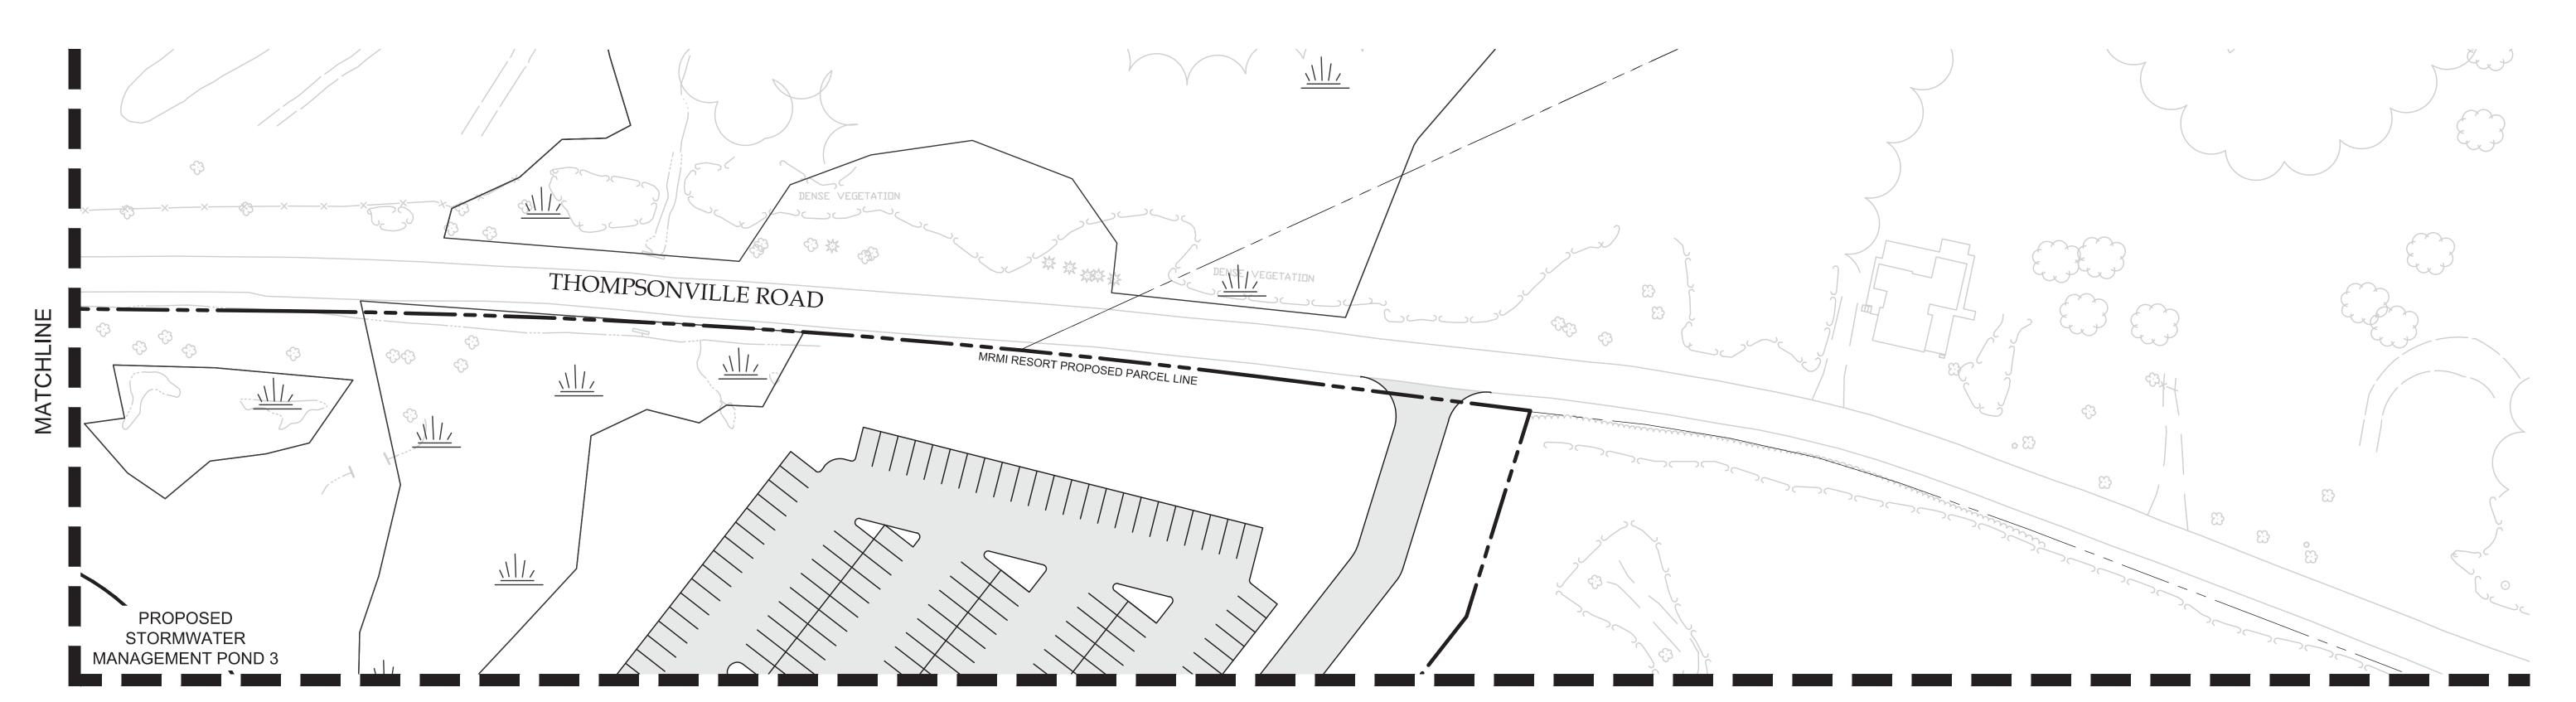

MATCHLINE - SEE TILE 2

0 20 40 80 SCALE: 1" = 40'

LEGEND

PARCEL LINE

MRMI RESORT PROPOSED

──────── PROPOSED CHAIN LINK FENCE

PROPOSED BUILDING

EXISTING TREE LINE

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MELICK-TULLY AND ASSOCIATES. F

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	ı	REVISIONS
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PHASE 1
TOWN OF THOMPSON
NEW YORK

DRAWN BY
JH, MH, DM, JT

SCALE
1"=40'

SHEET TITLE

CHECKED BY
AM, KF, JM


AM, KF, JM


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SITE GEOMETRY PLAN


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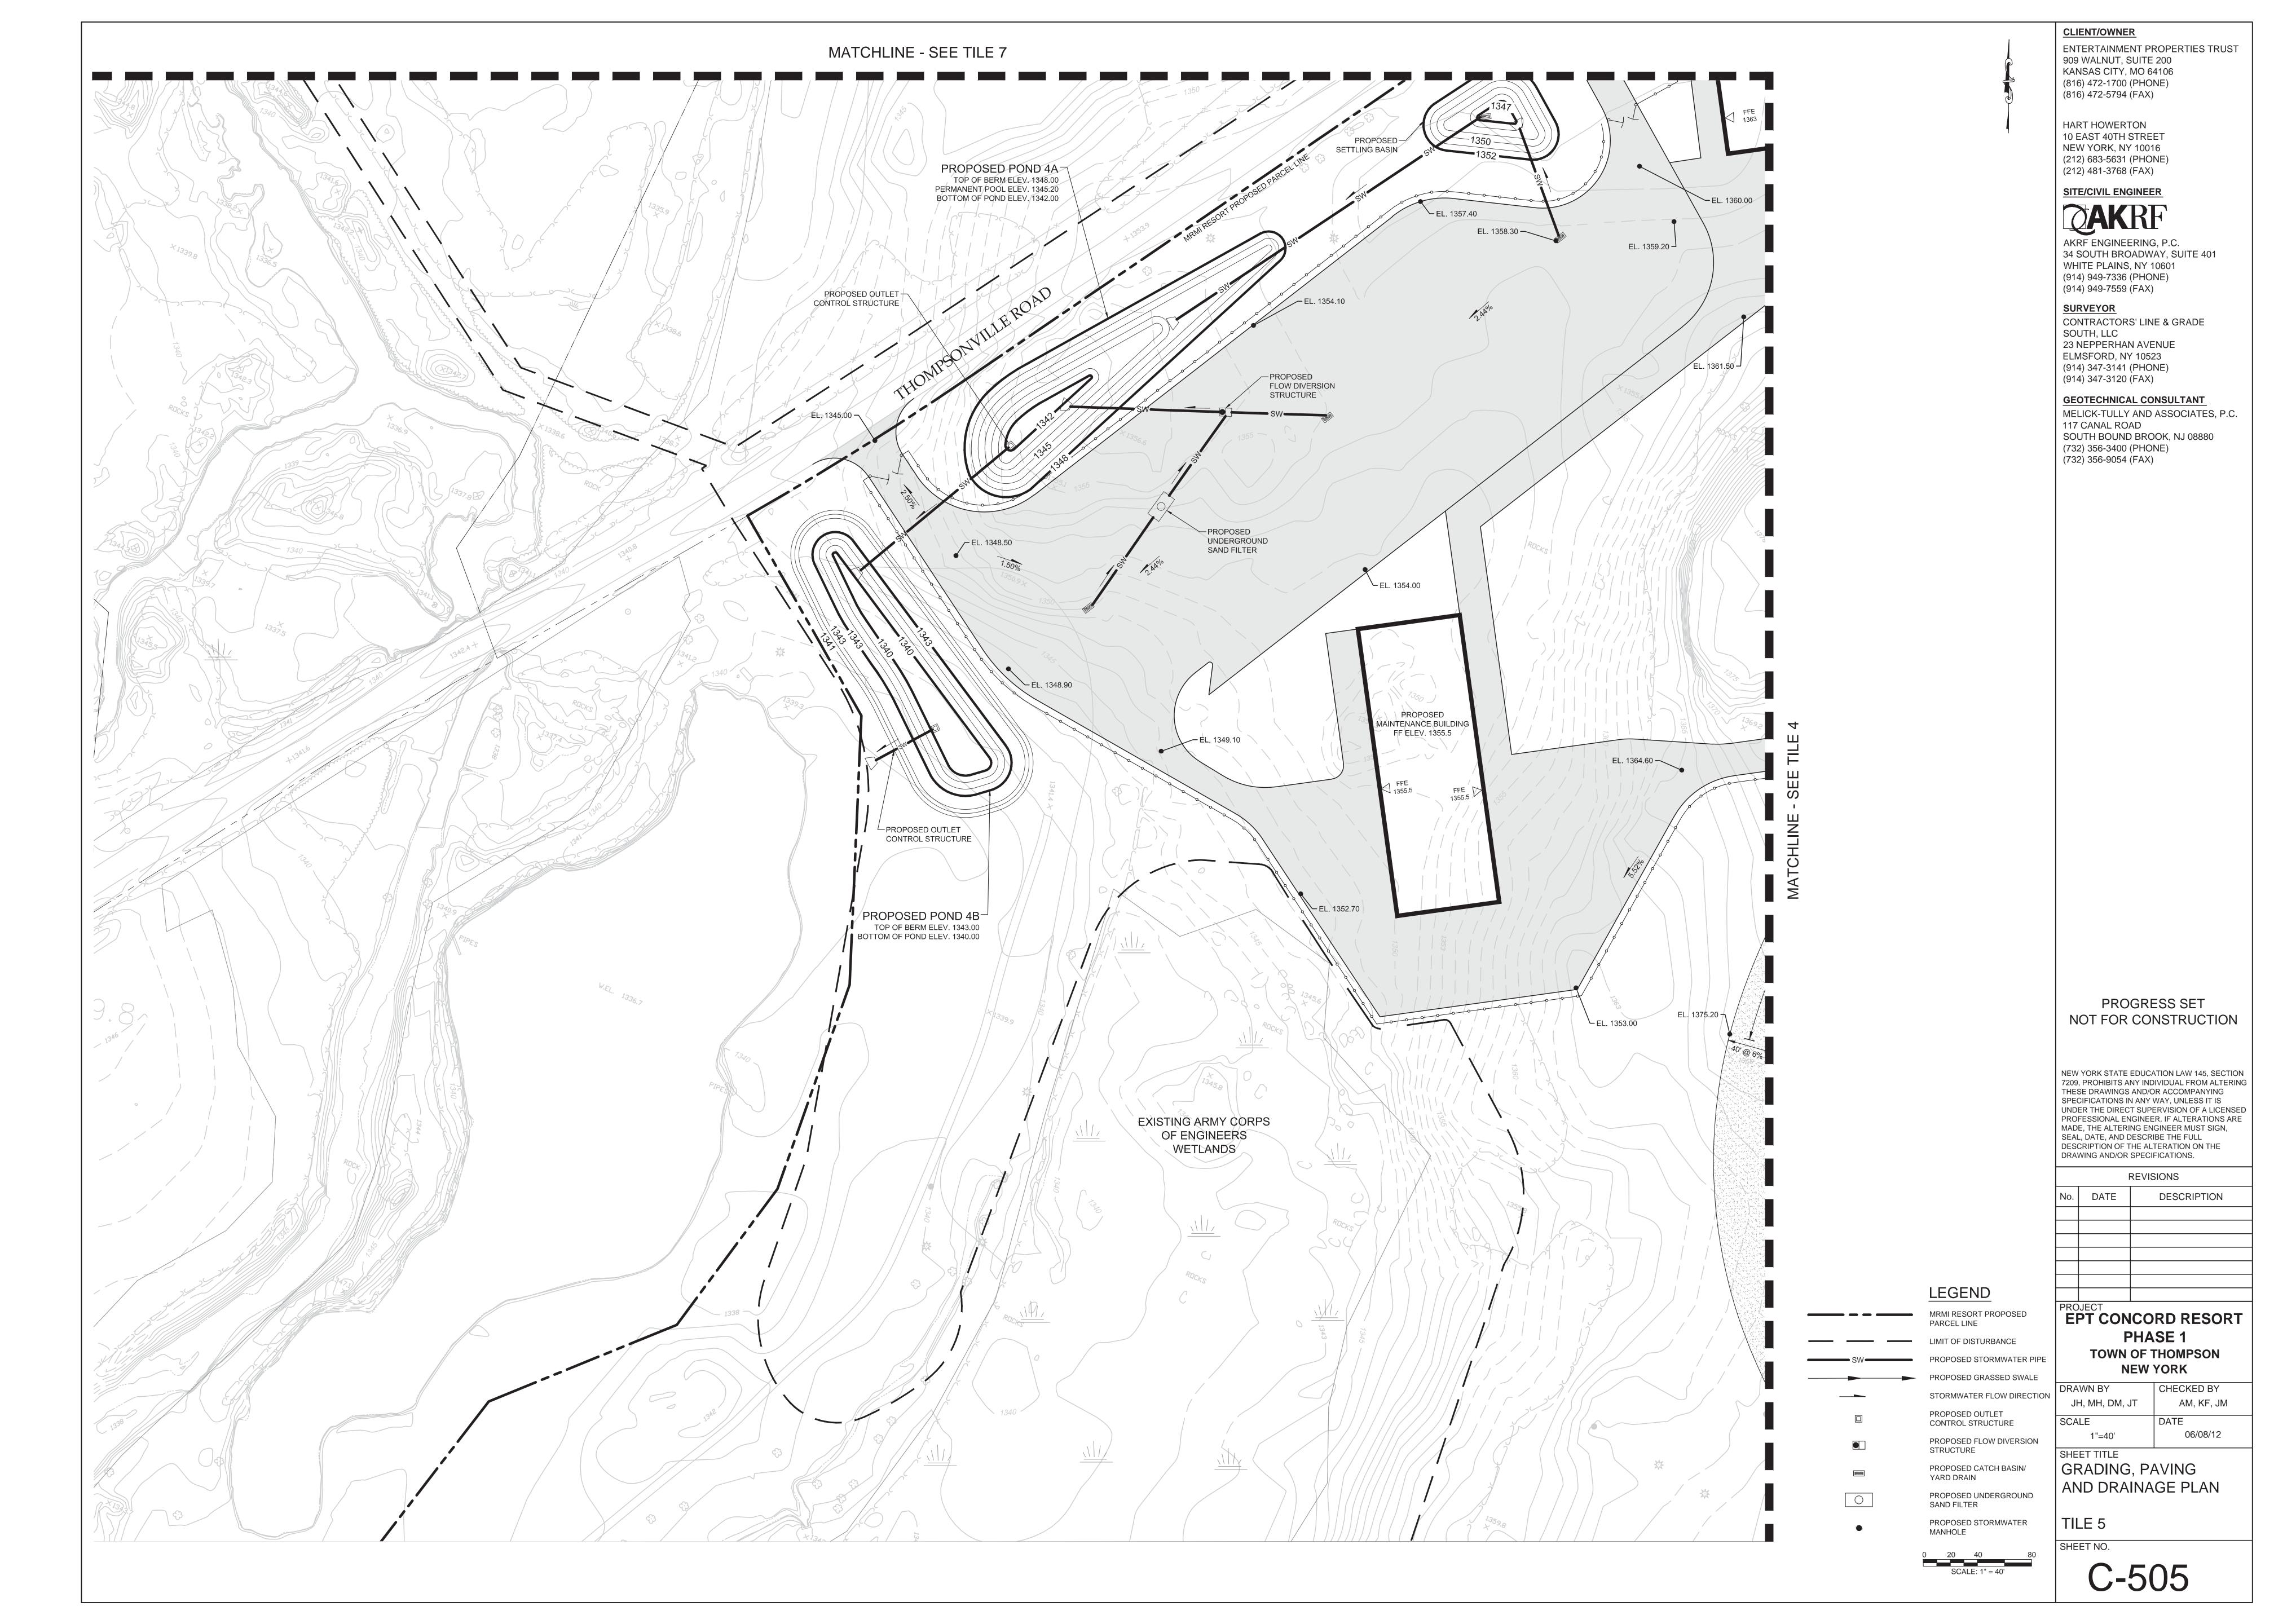








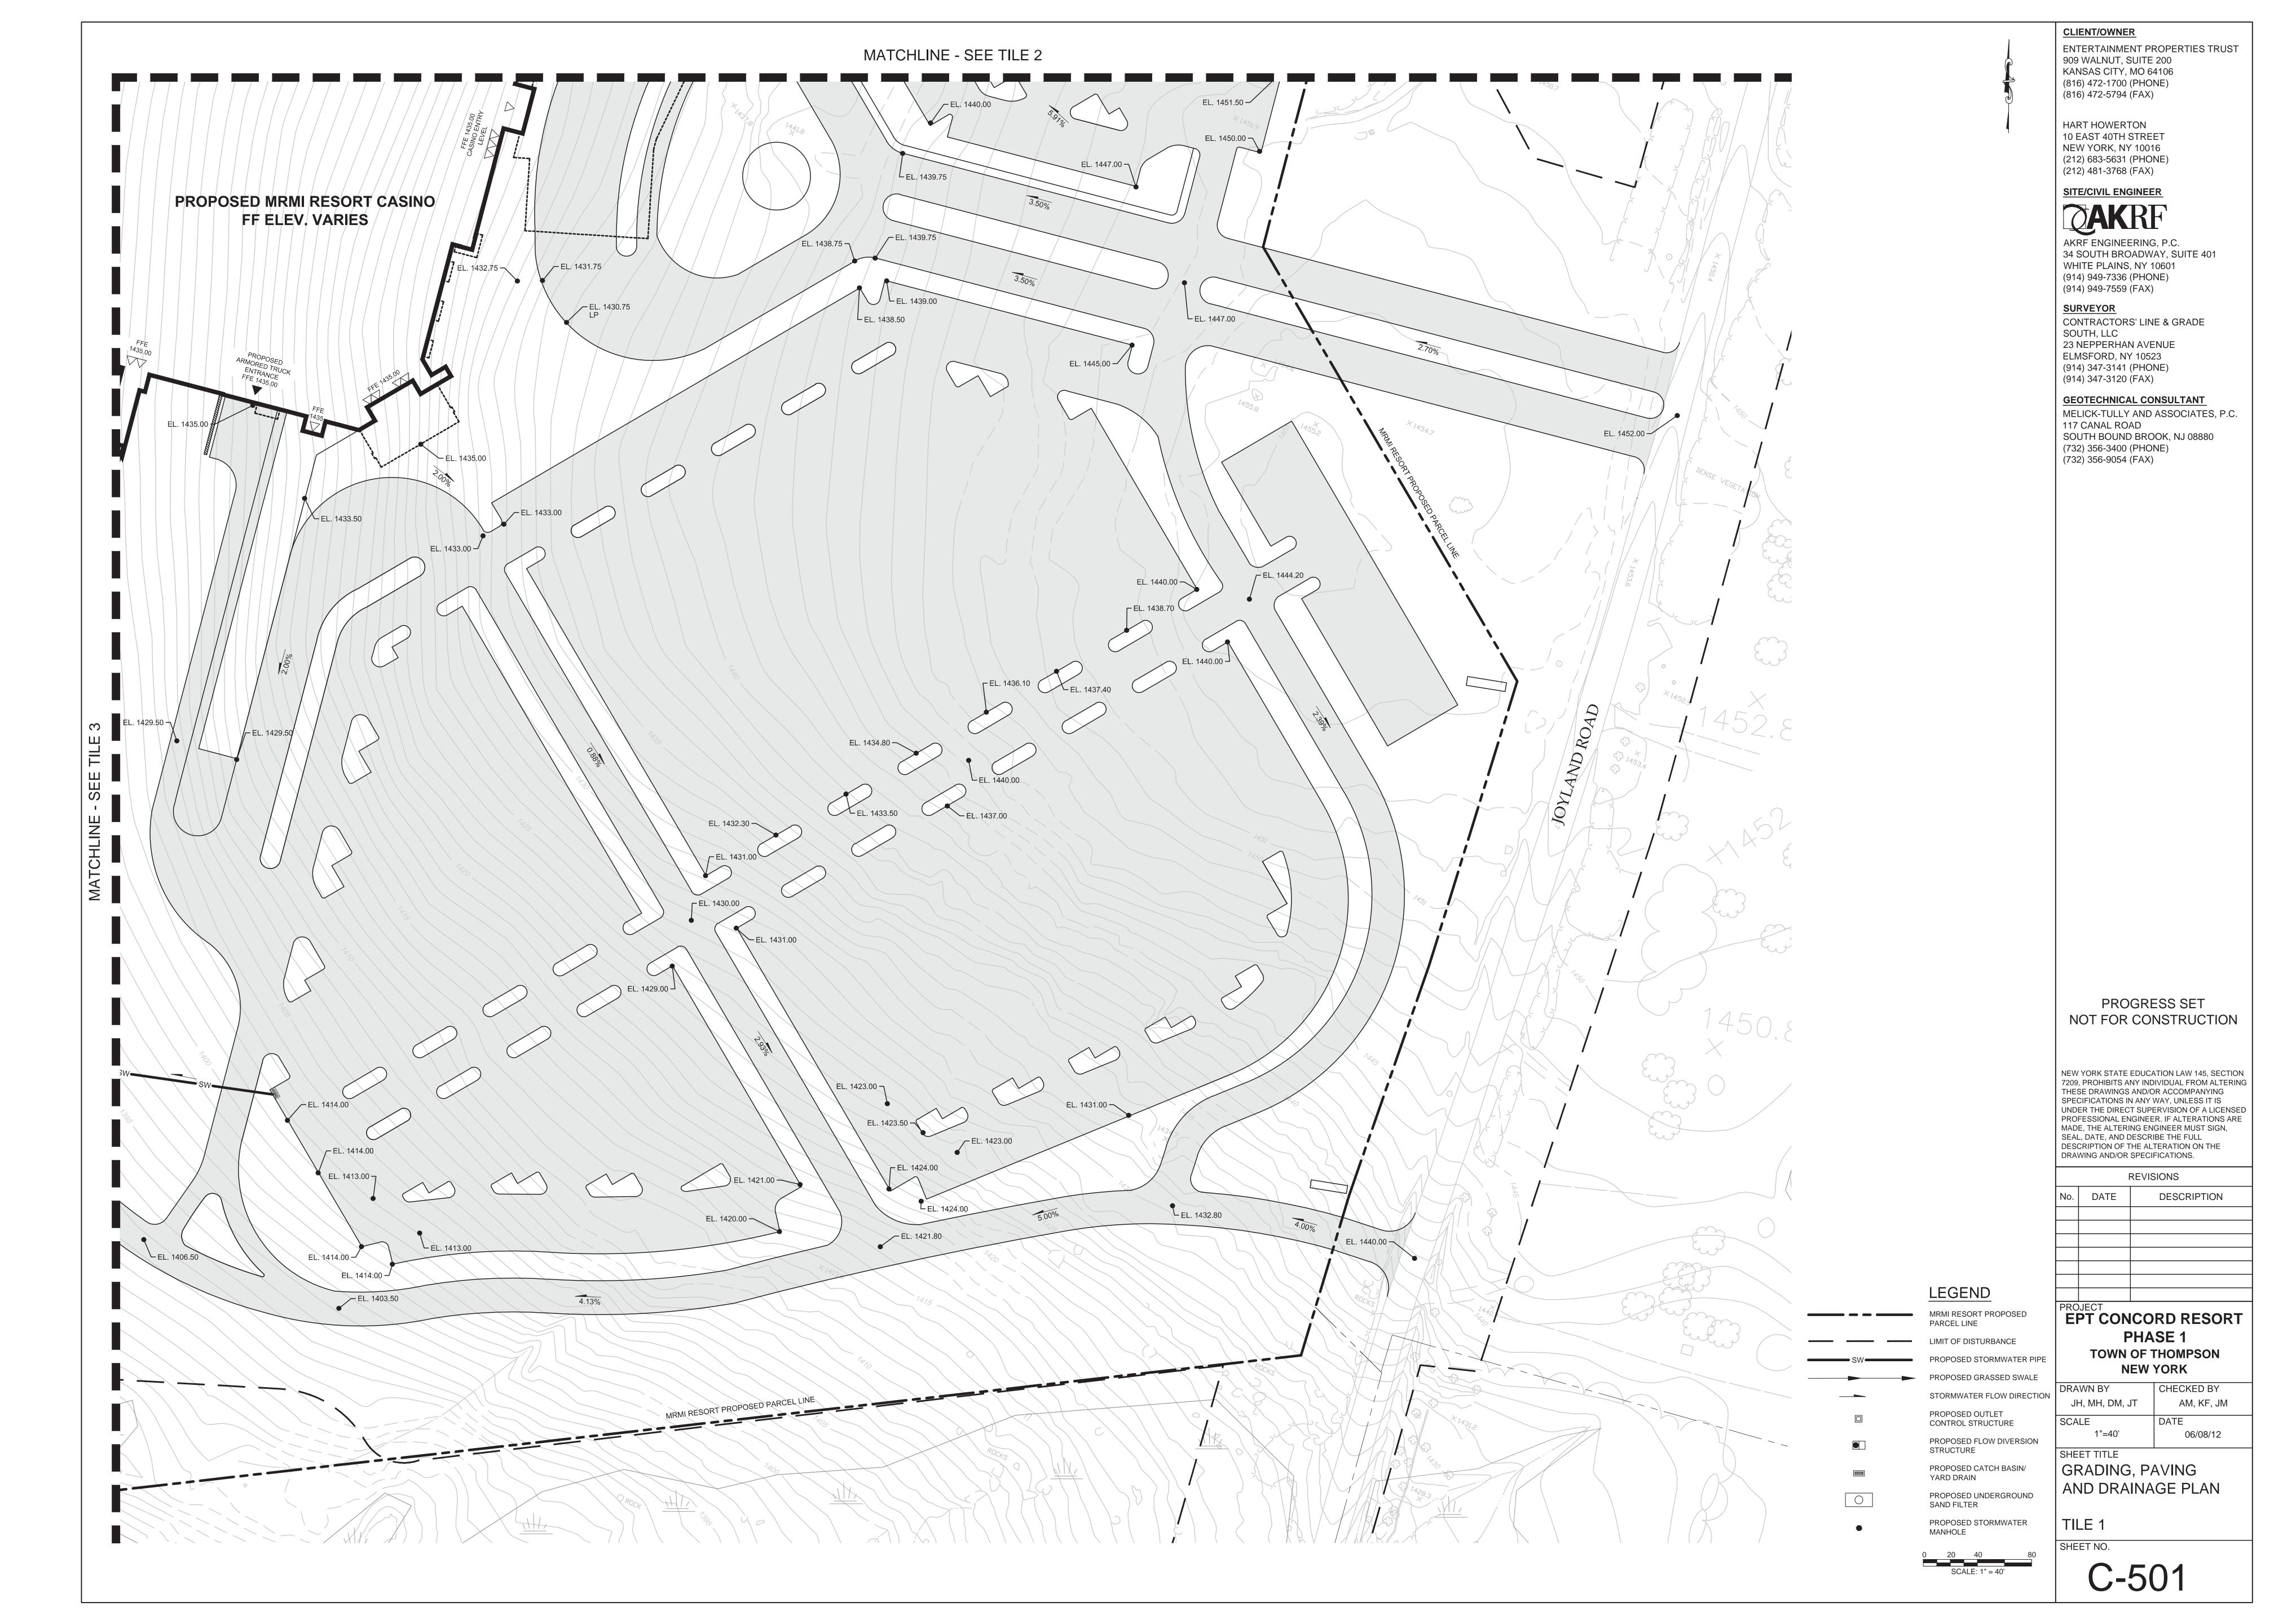

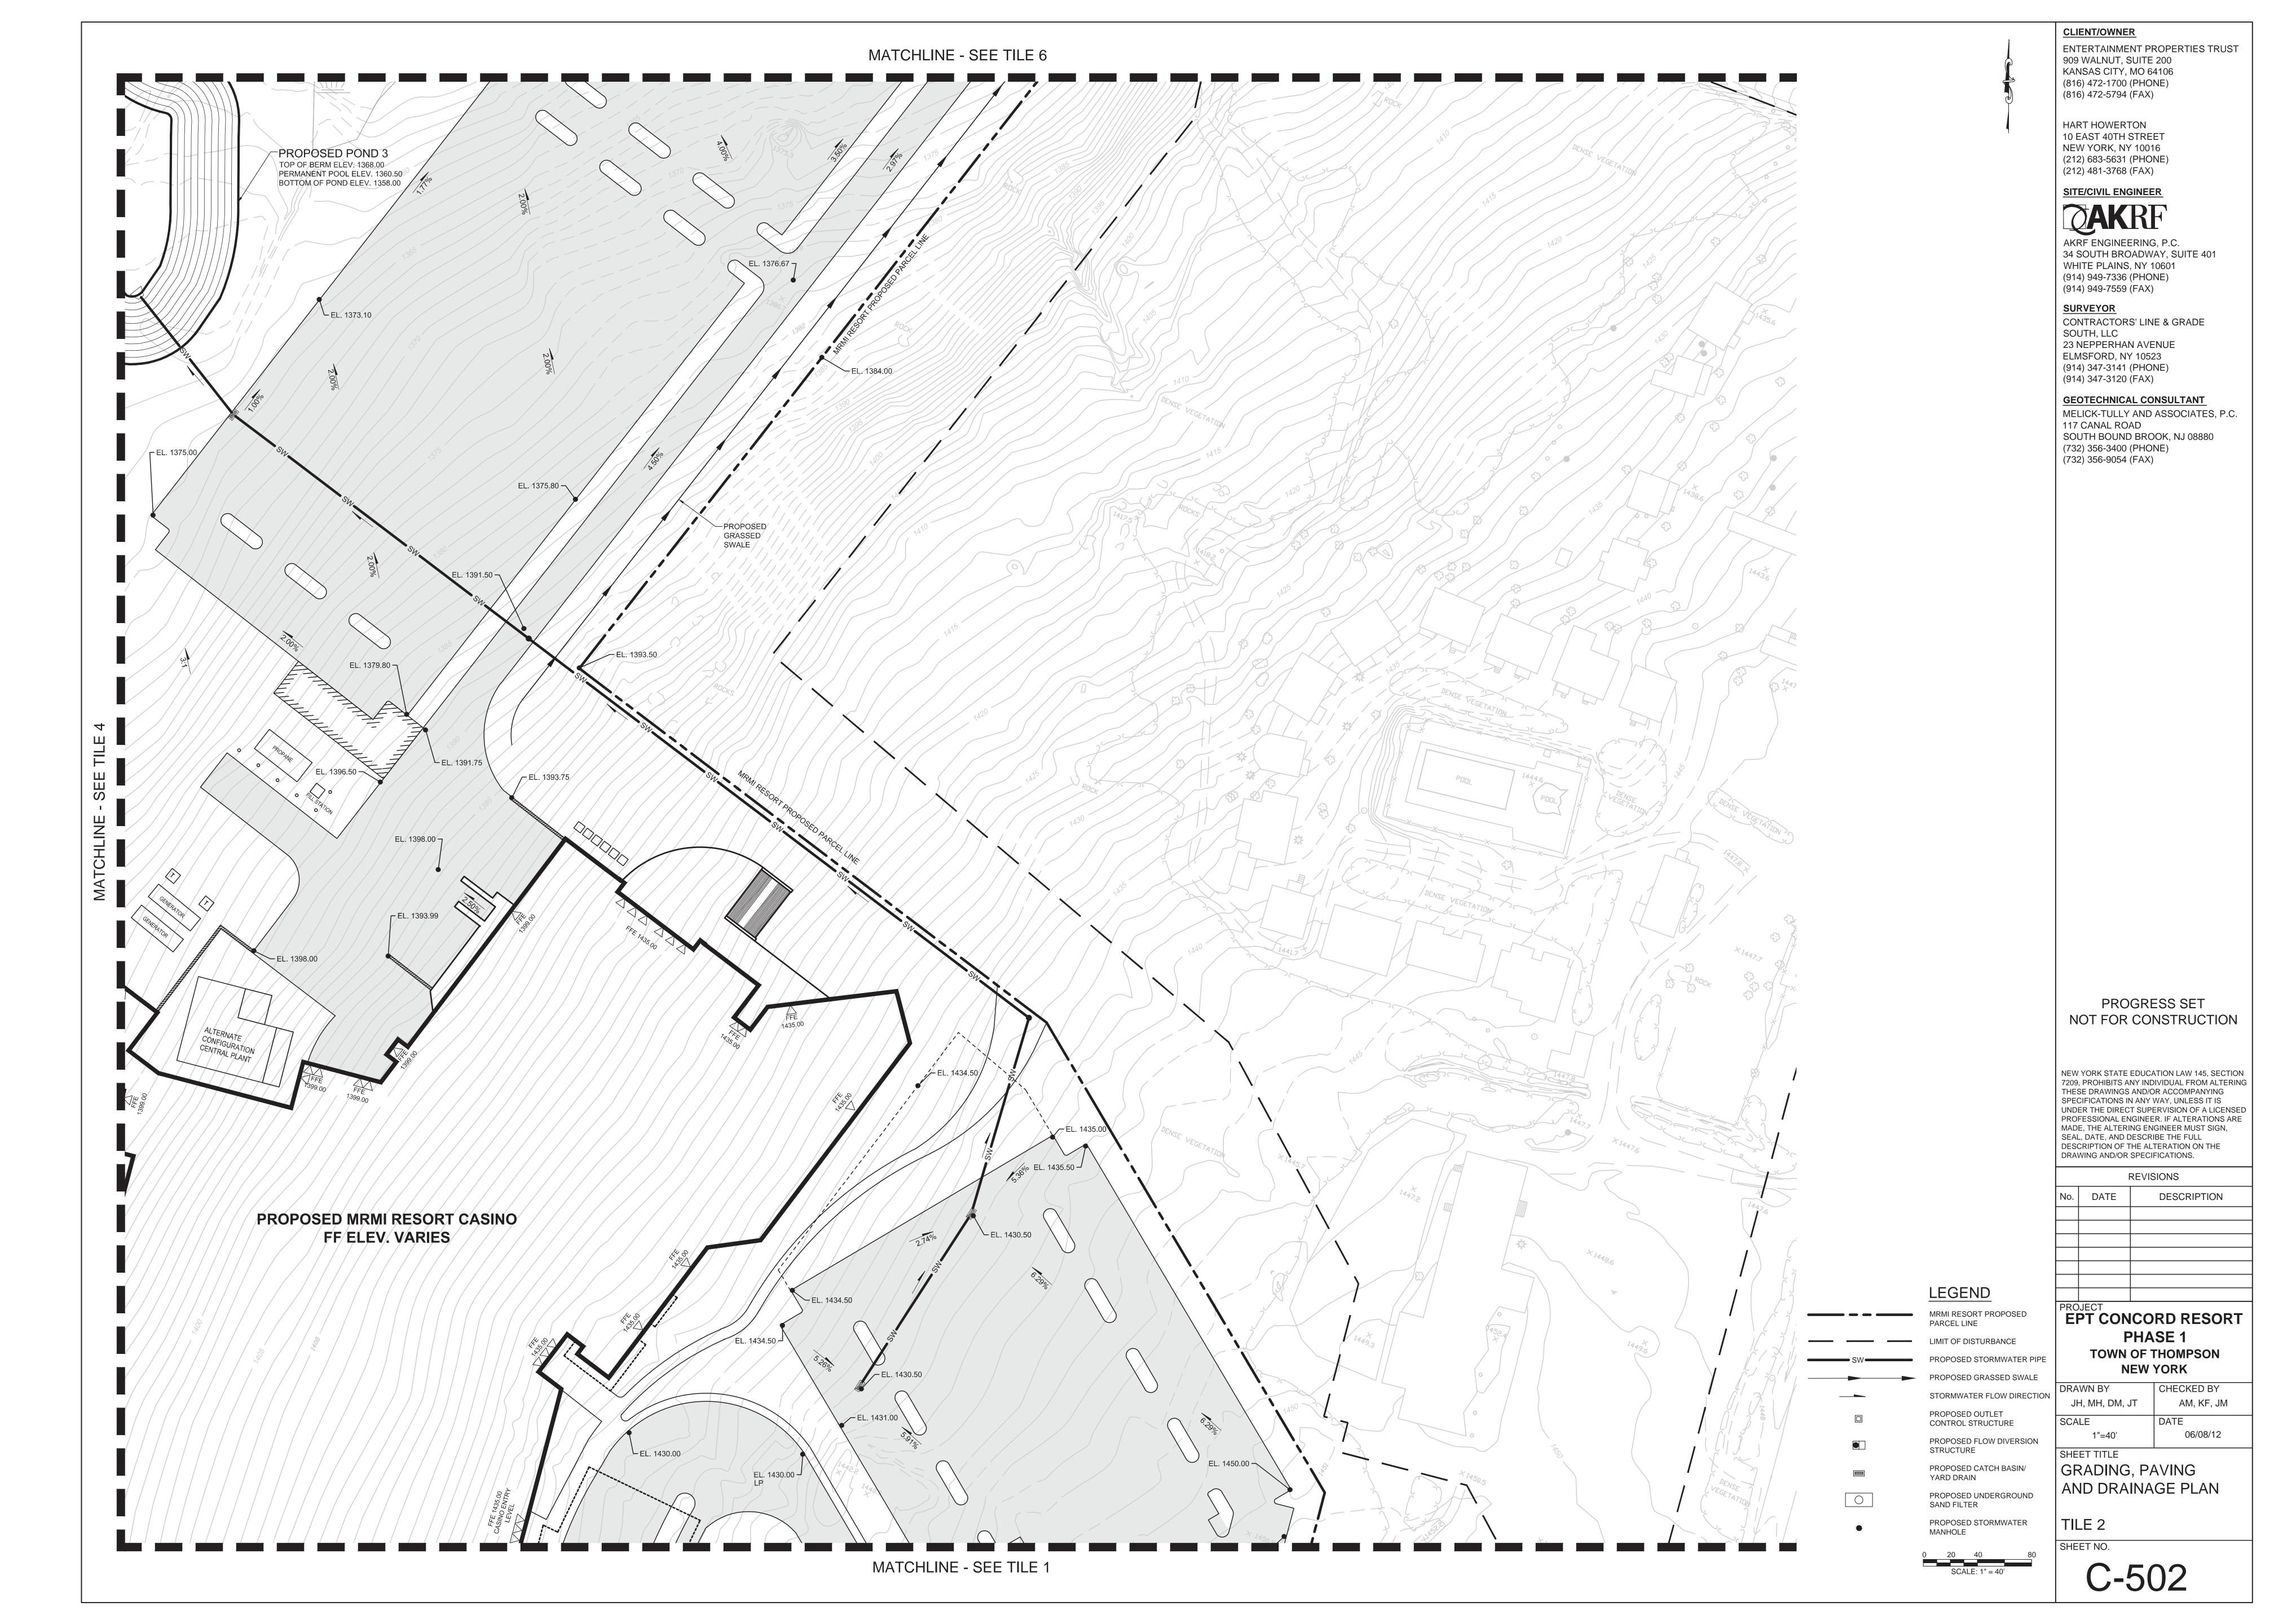

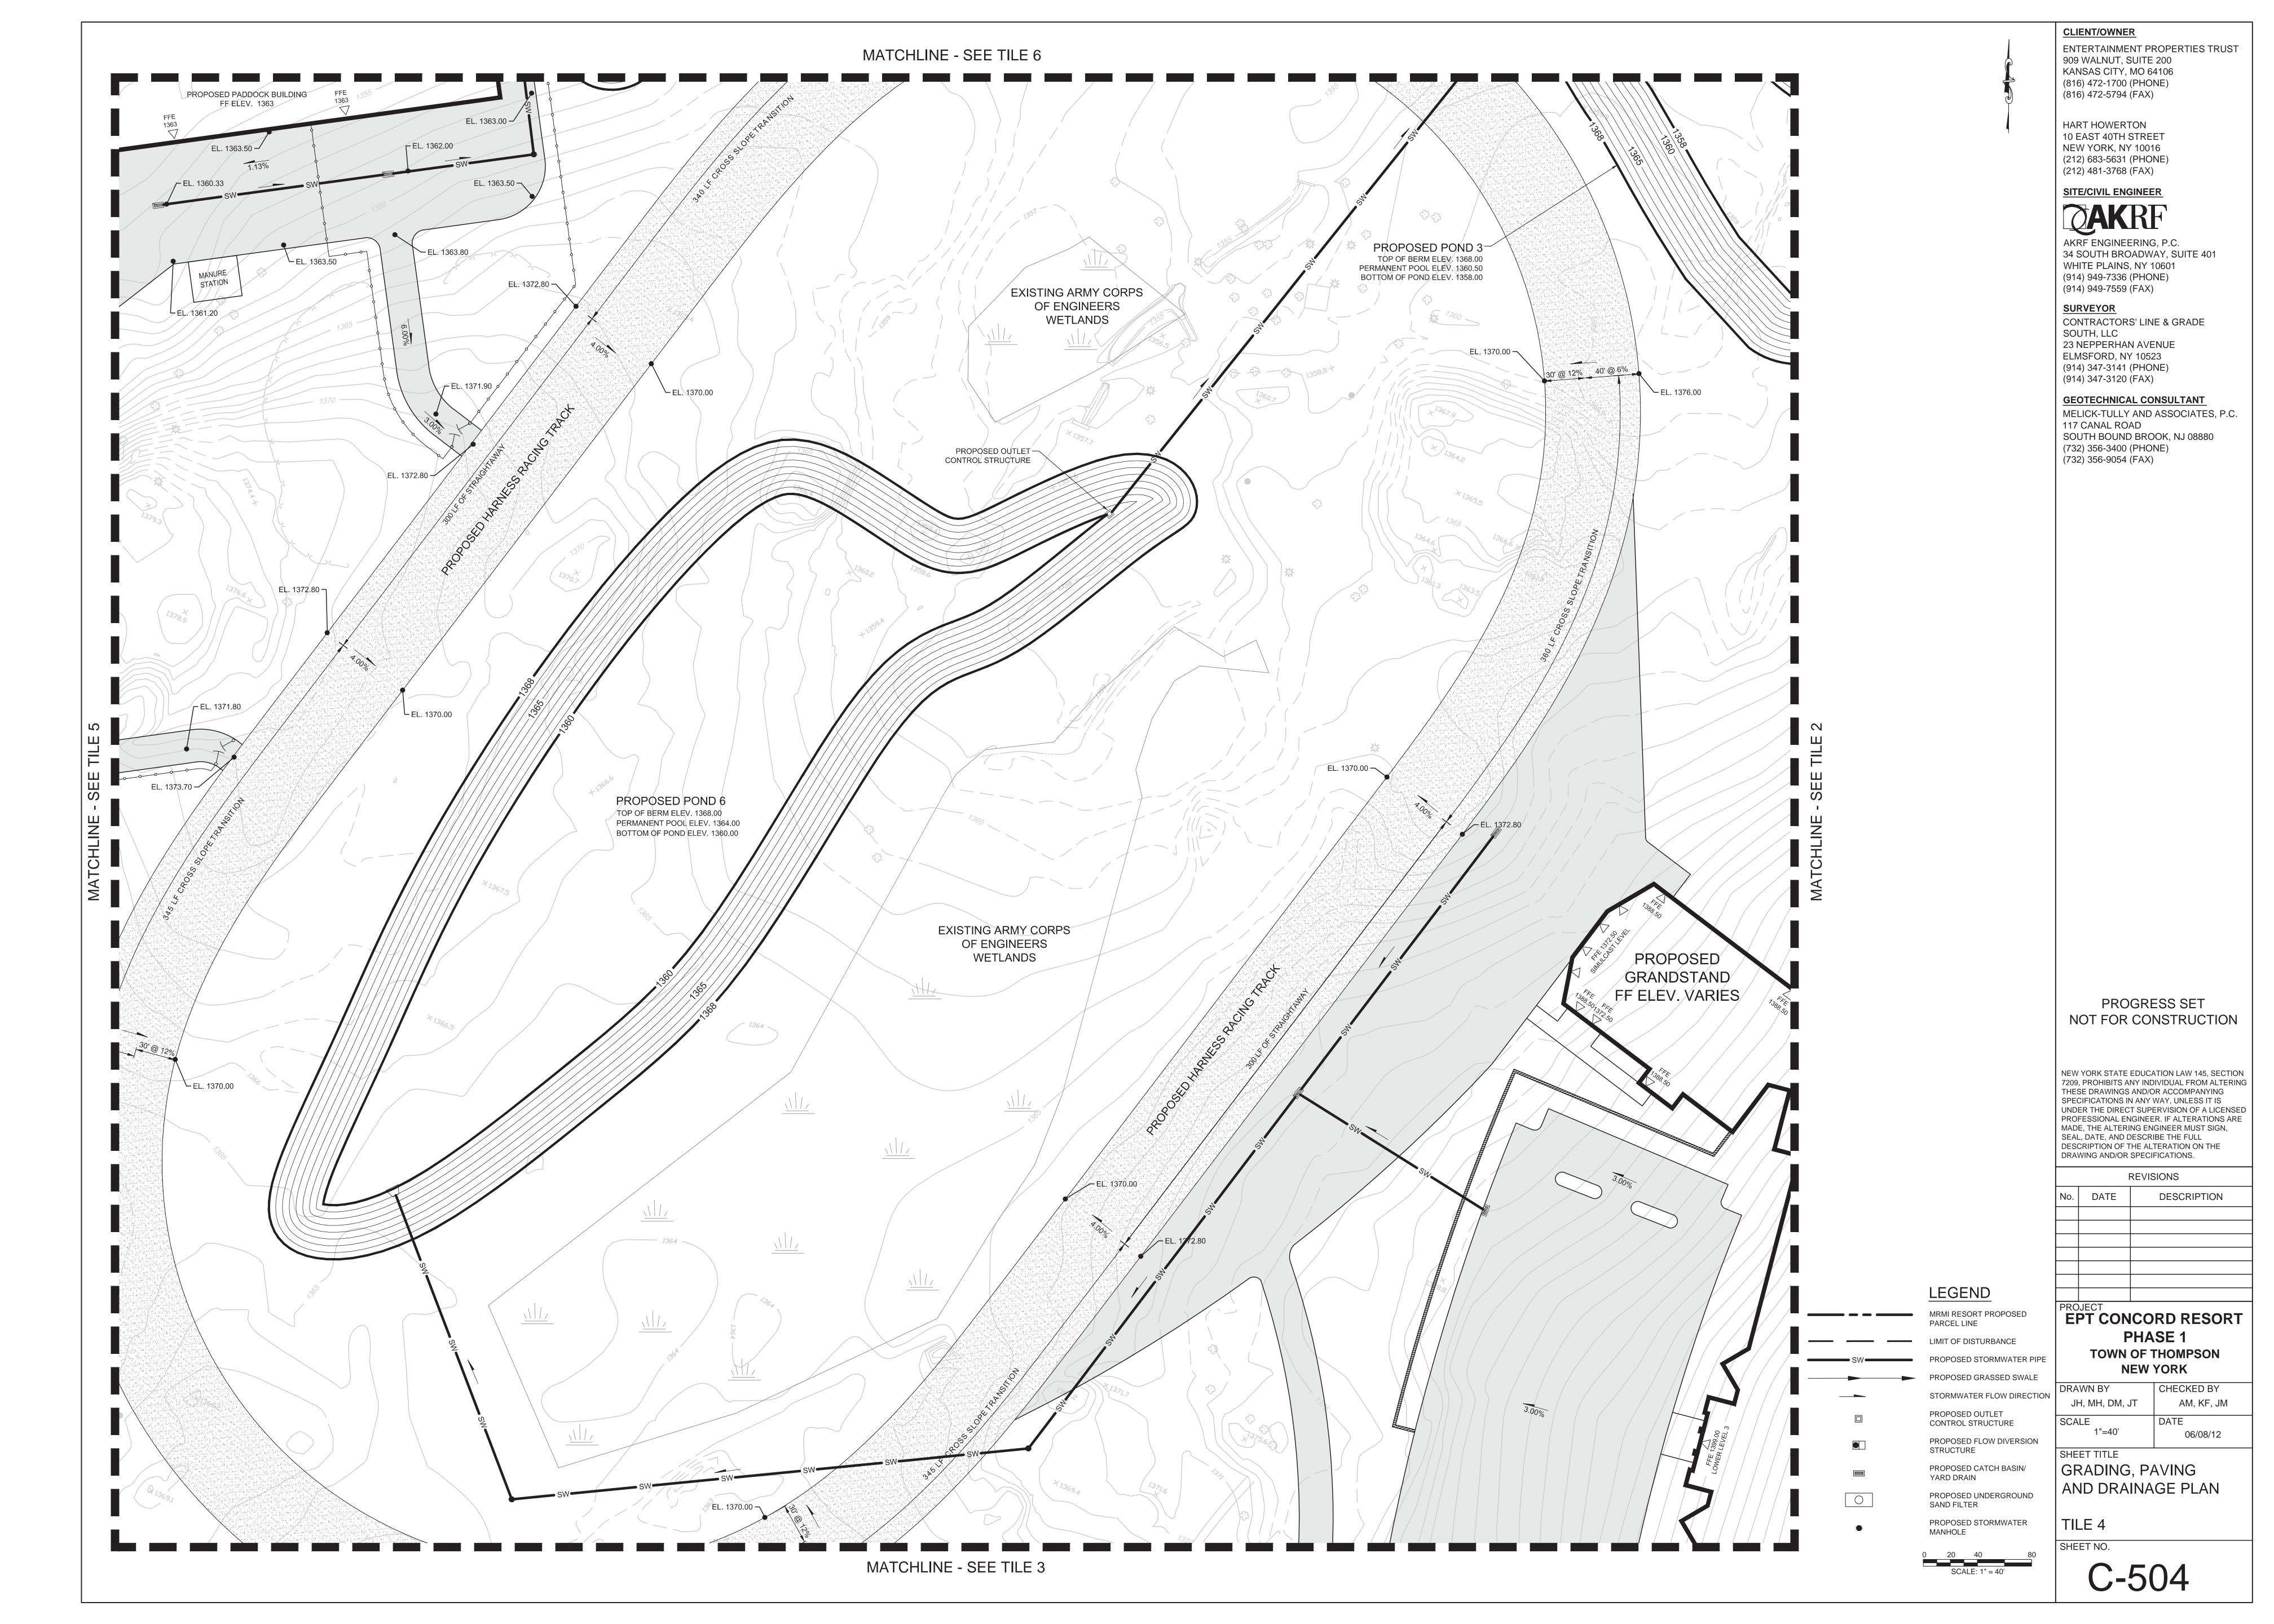

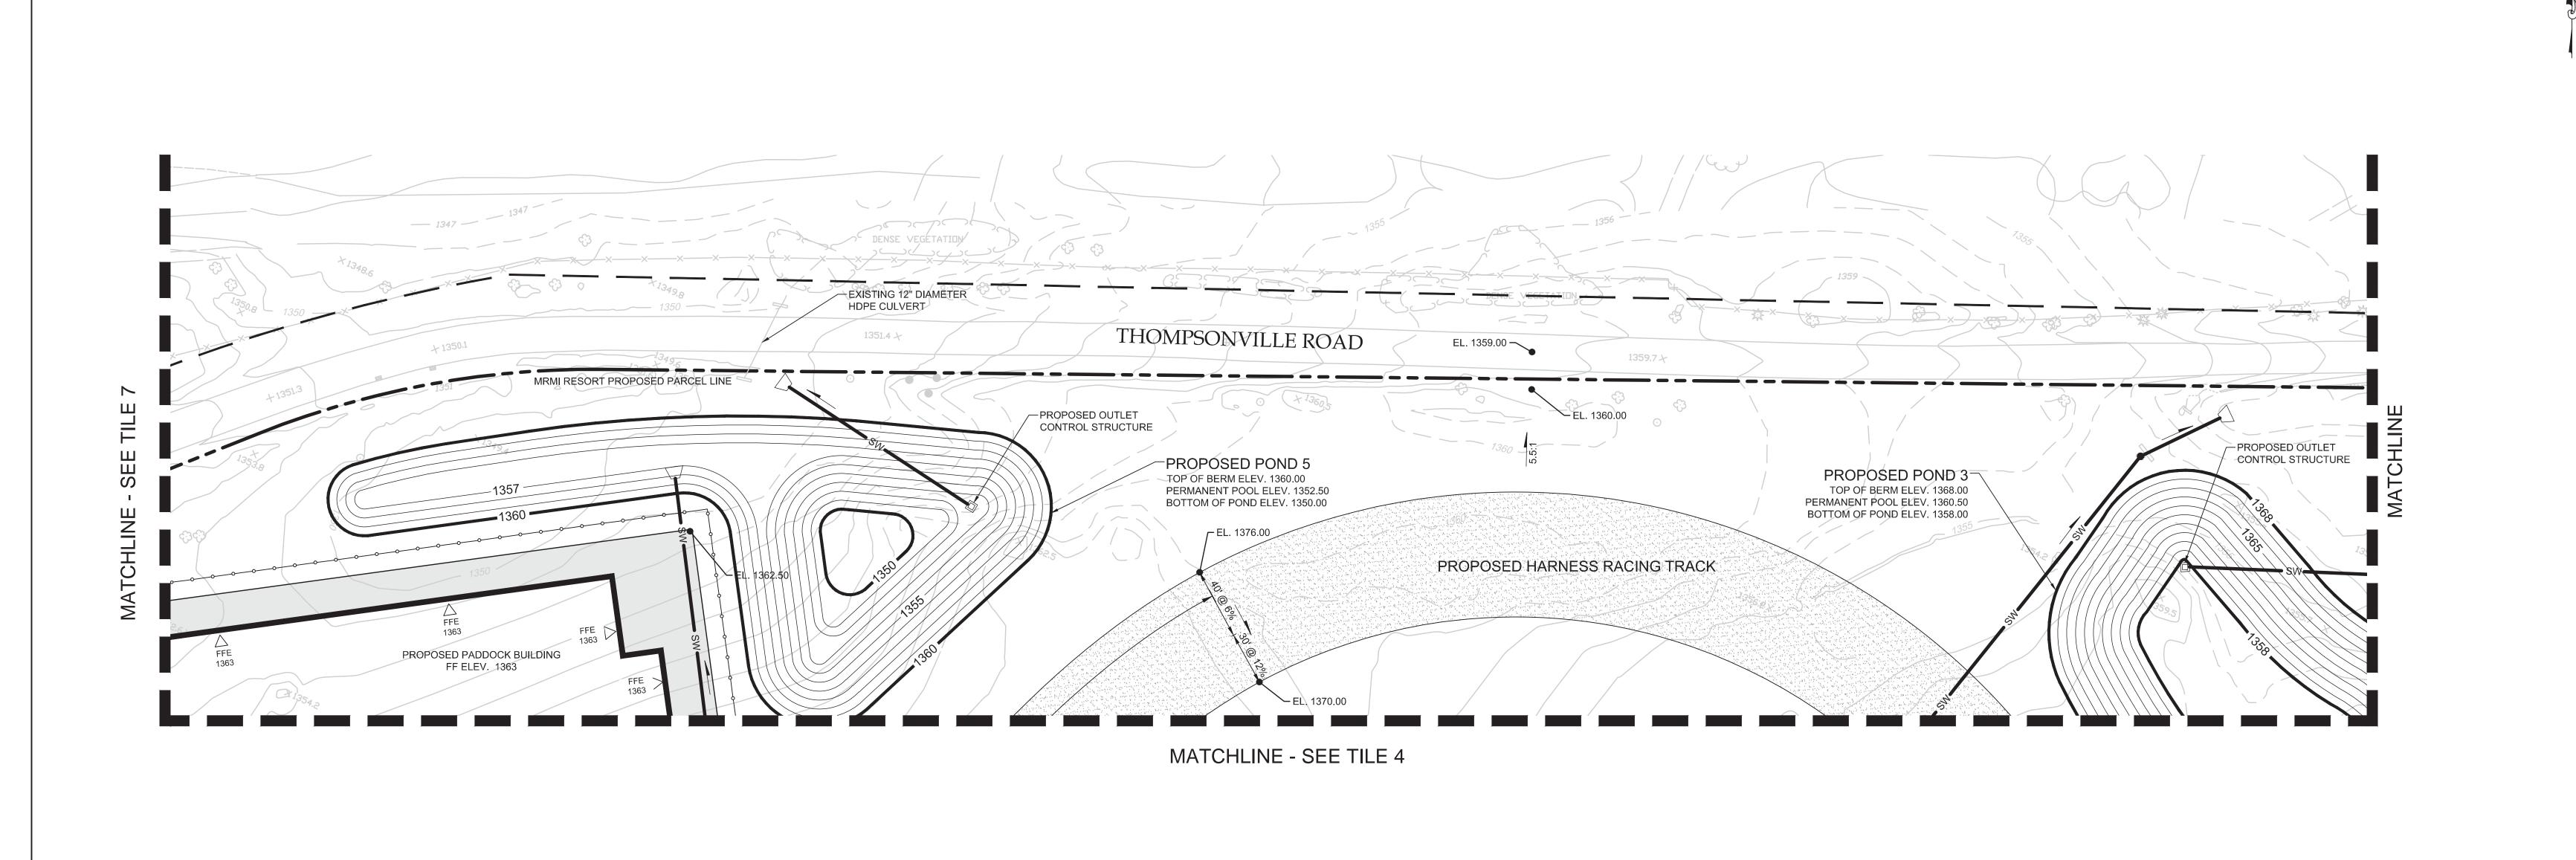

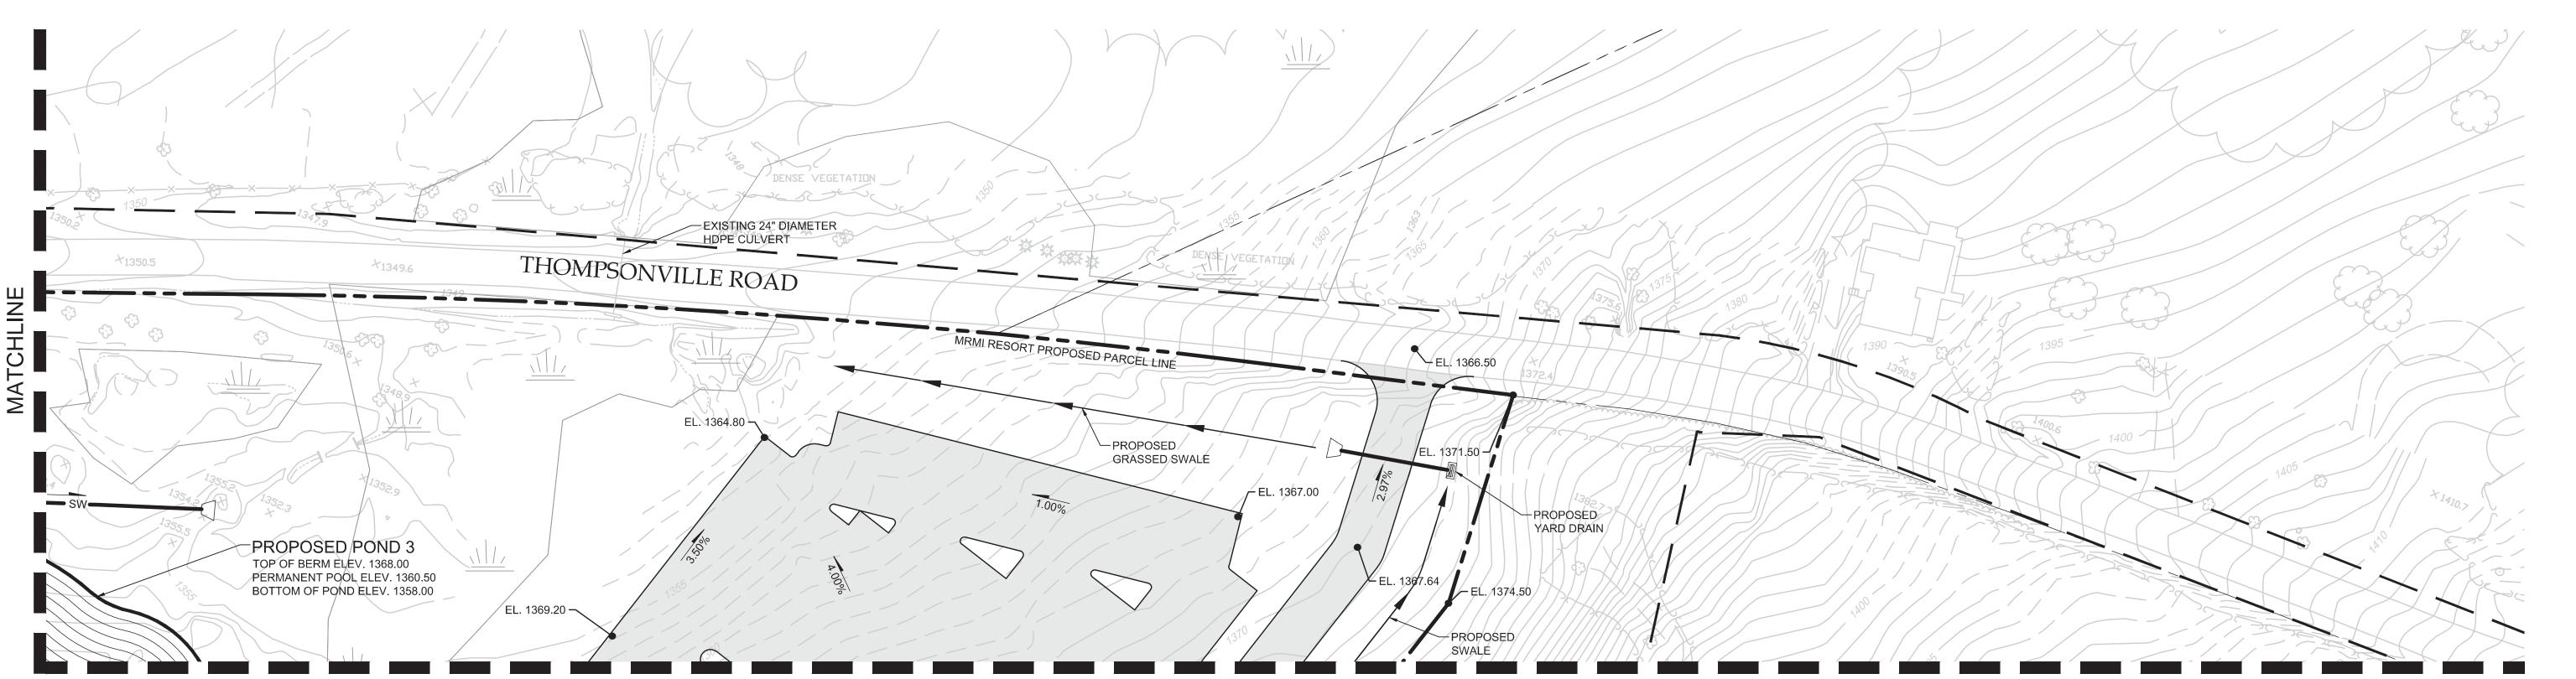

MATCHLINE - SEE TILE 2

LEGEND MRMI RESORT PROPOSED PARCEL LINE LIMIT OF DISTURBANCE PROPOSED STORMWATER PIPE PROPOSED GRASSED SWALE STORMWATER FLOW DIRECTION PROPOSED OUTLET CONTROL STRUCTURE PROPOSED FLOW DIVERSION STRUCTURE PROPOSED CATCH BASIN/ YARD DRAIN PROPOSED UNDERGROUND SAND FILTER PROPOSED STORMWATER SHEET NO. MANHOLE

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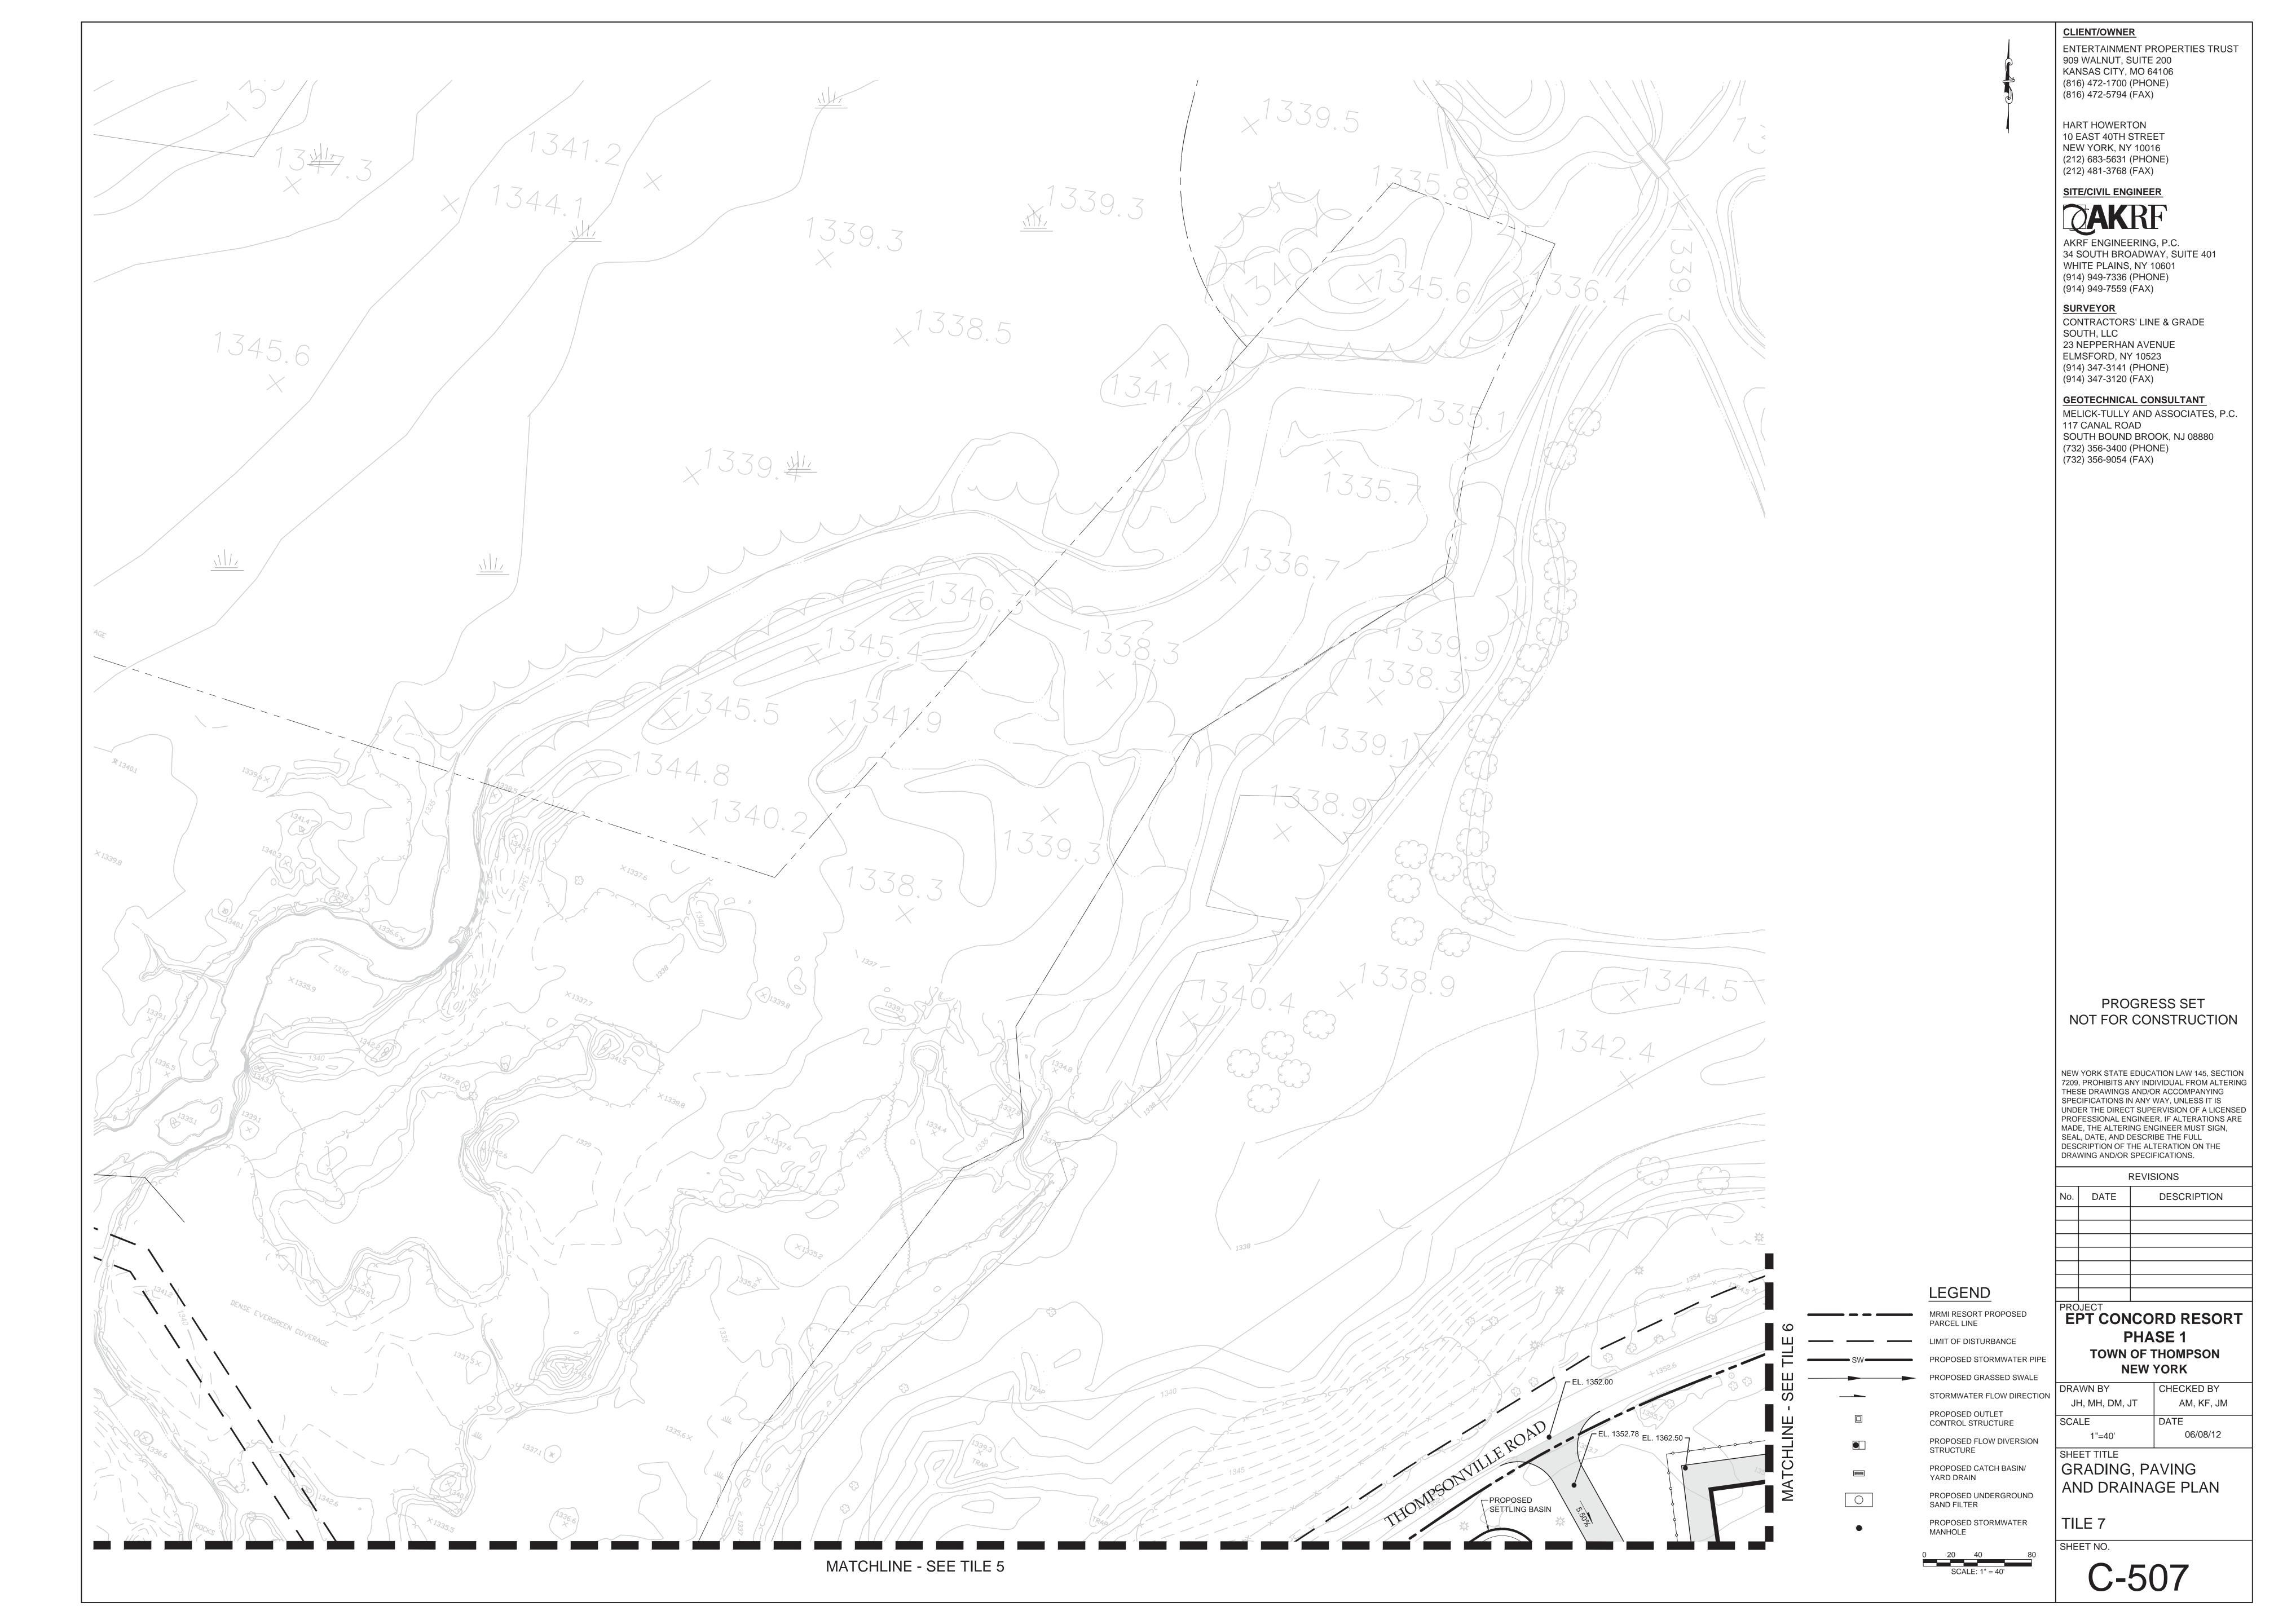
REVISIONS DESCRIPTION PROJECT
EPT CONCORD RESORT


PHASE 1 TOWN OF THOMPSON **NEW YORK**


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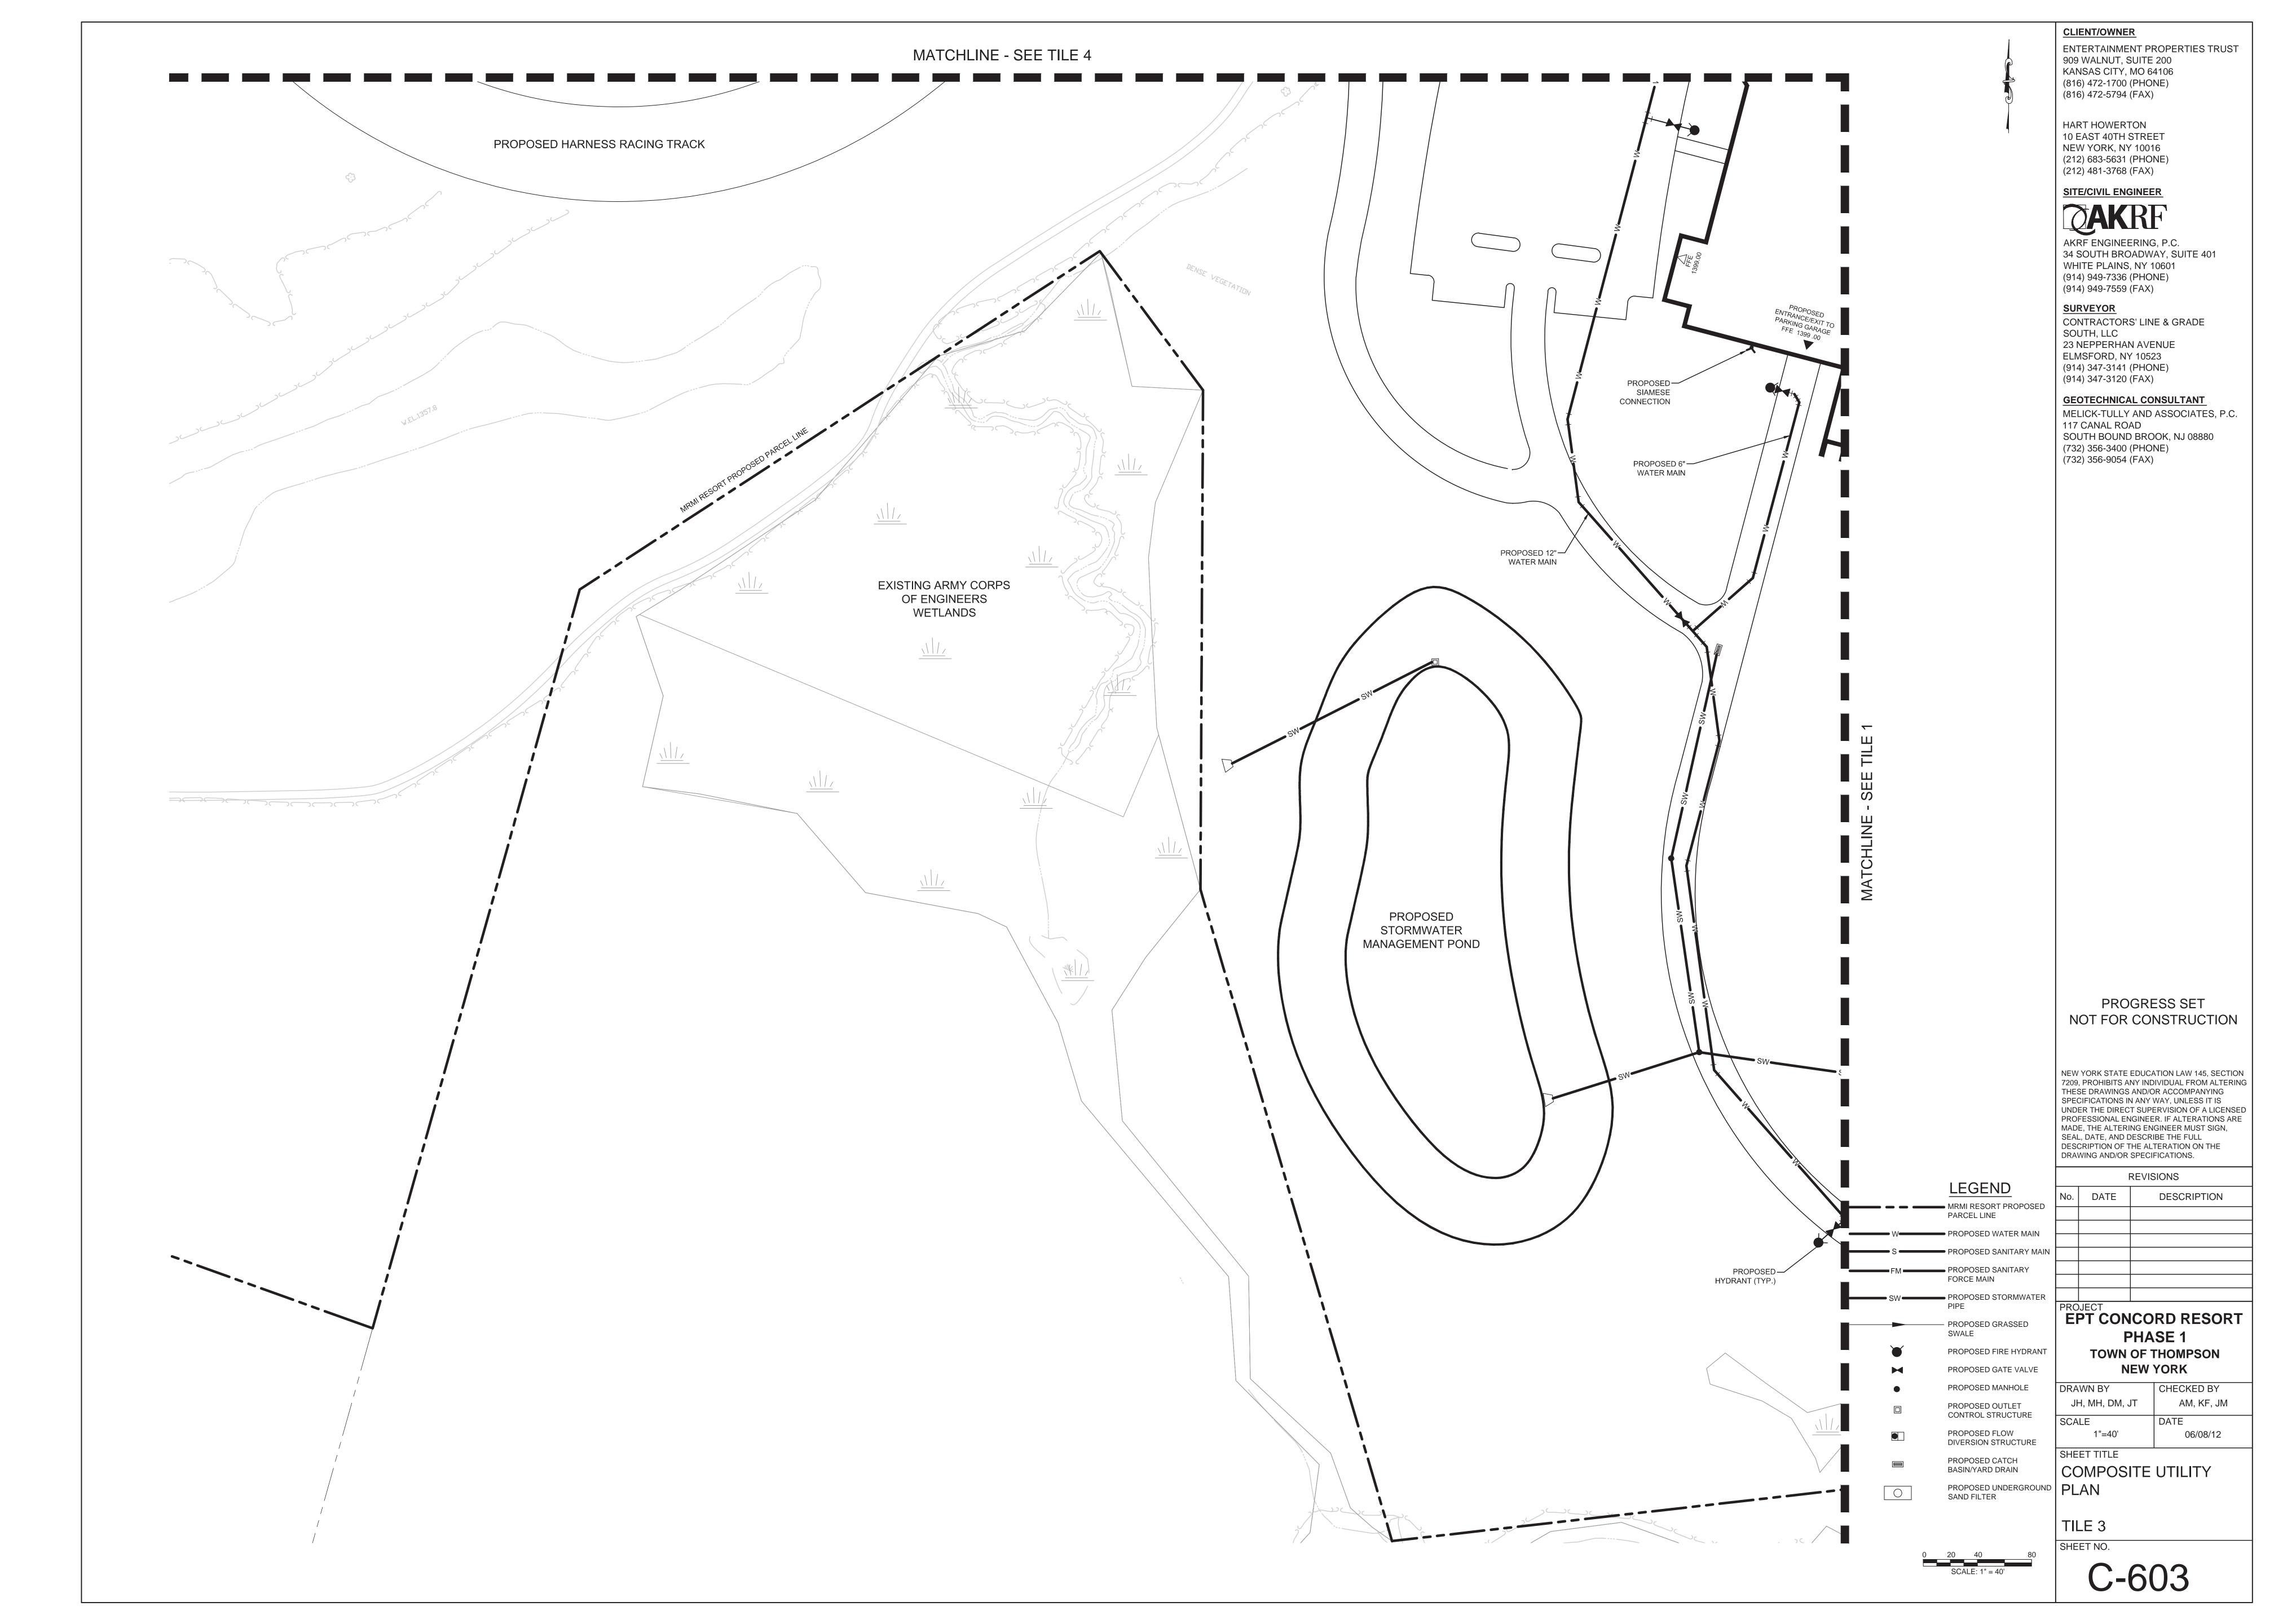
SHEET TITLE GRADING, PAVING AND DRAINAGE PLAN


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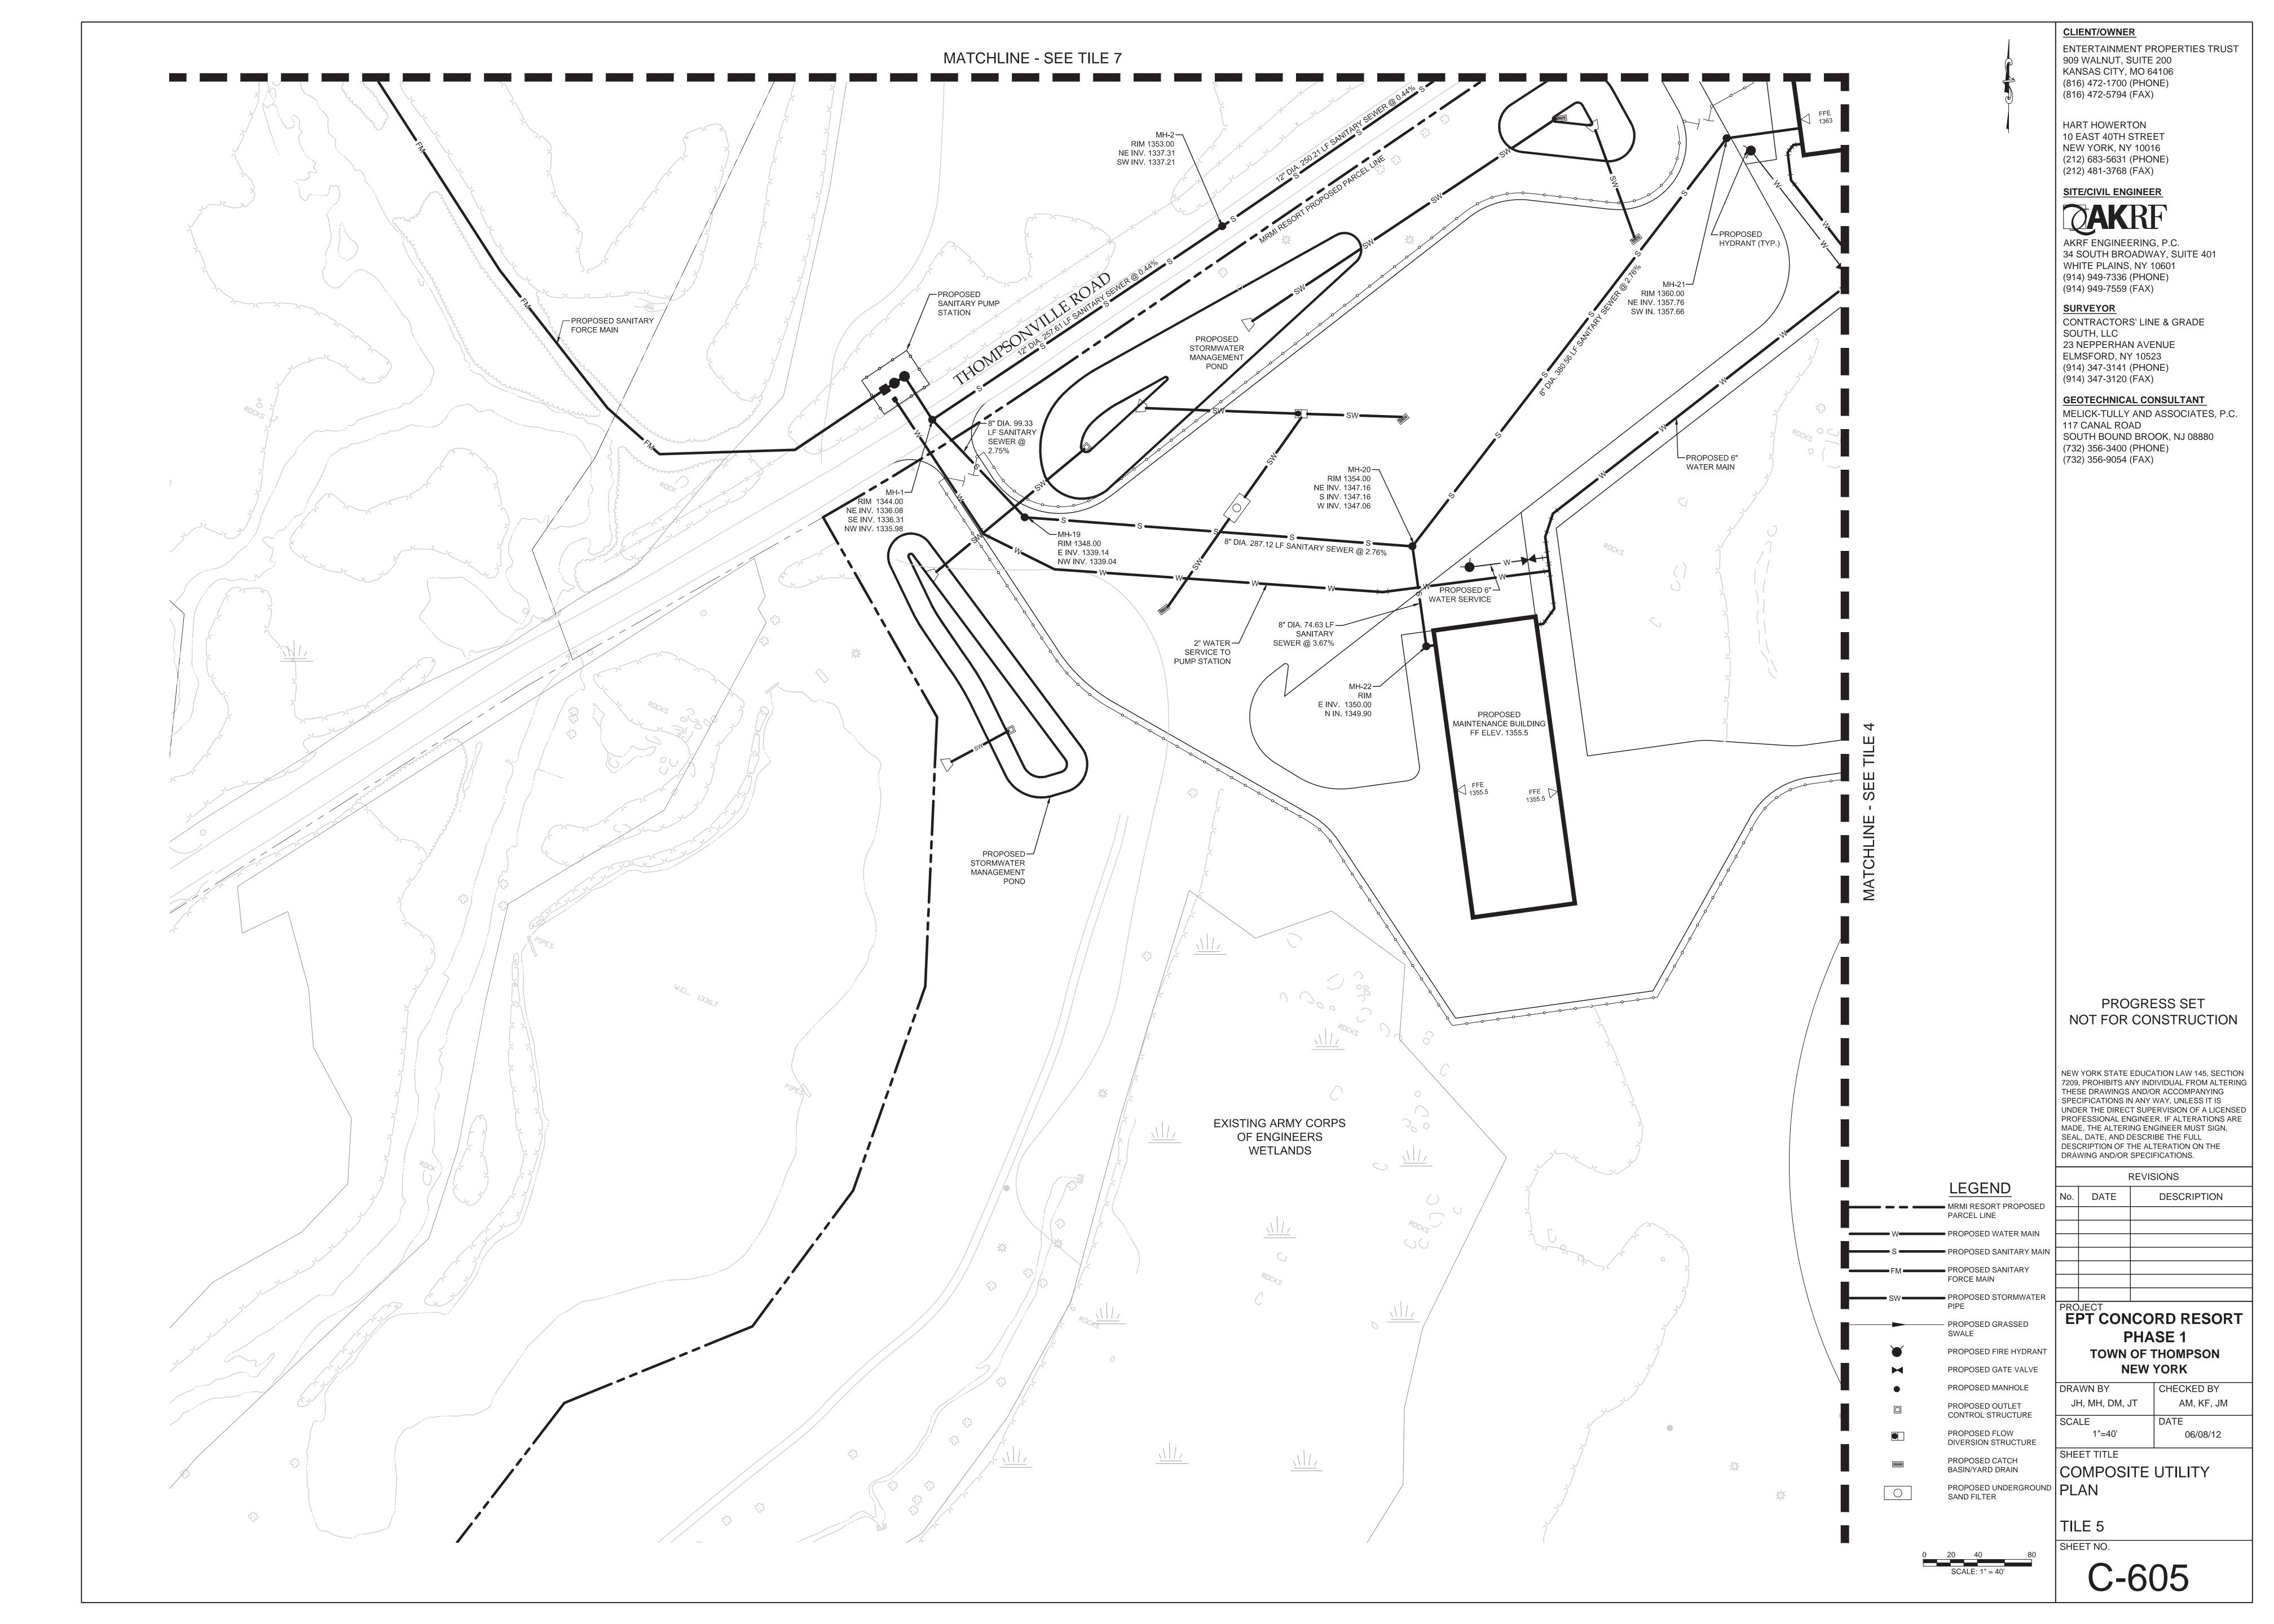








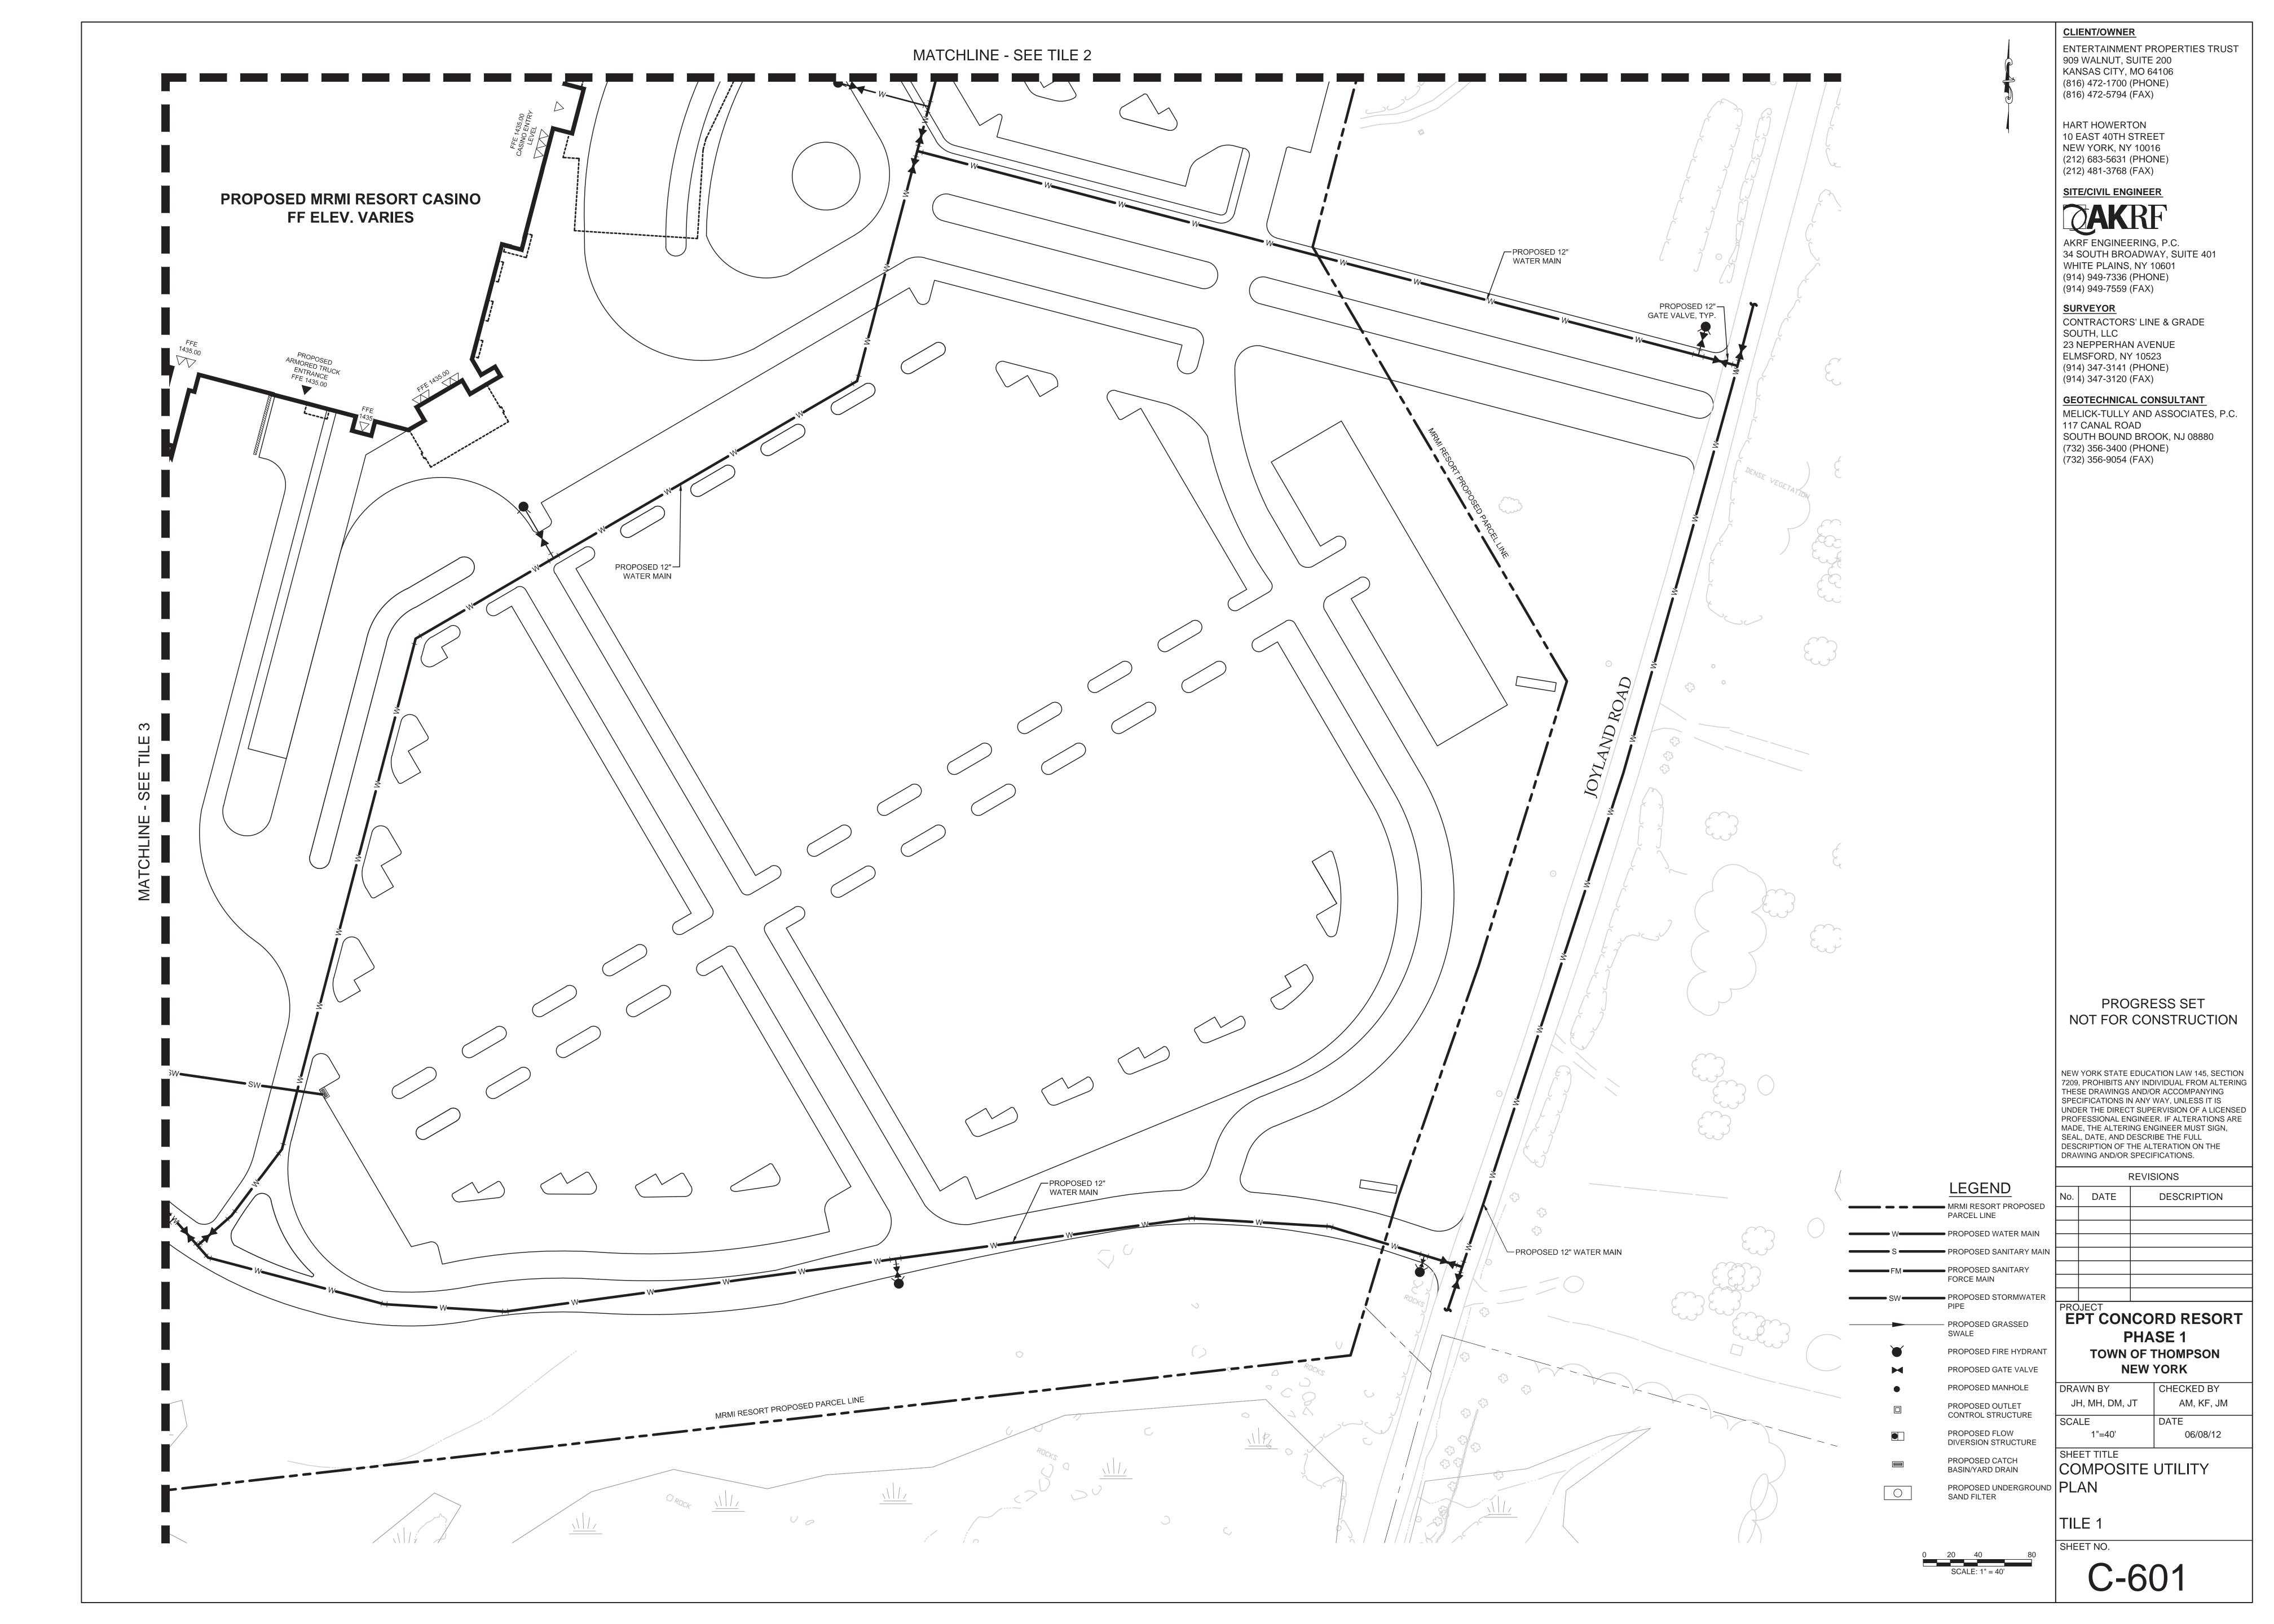

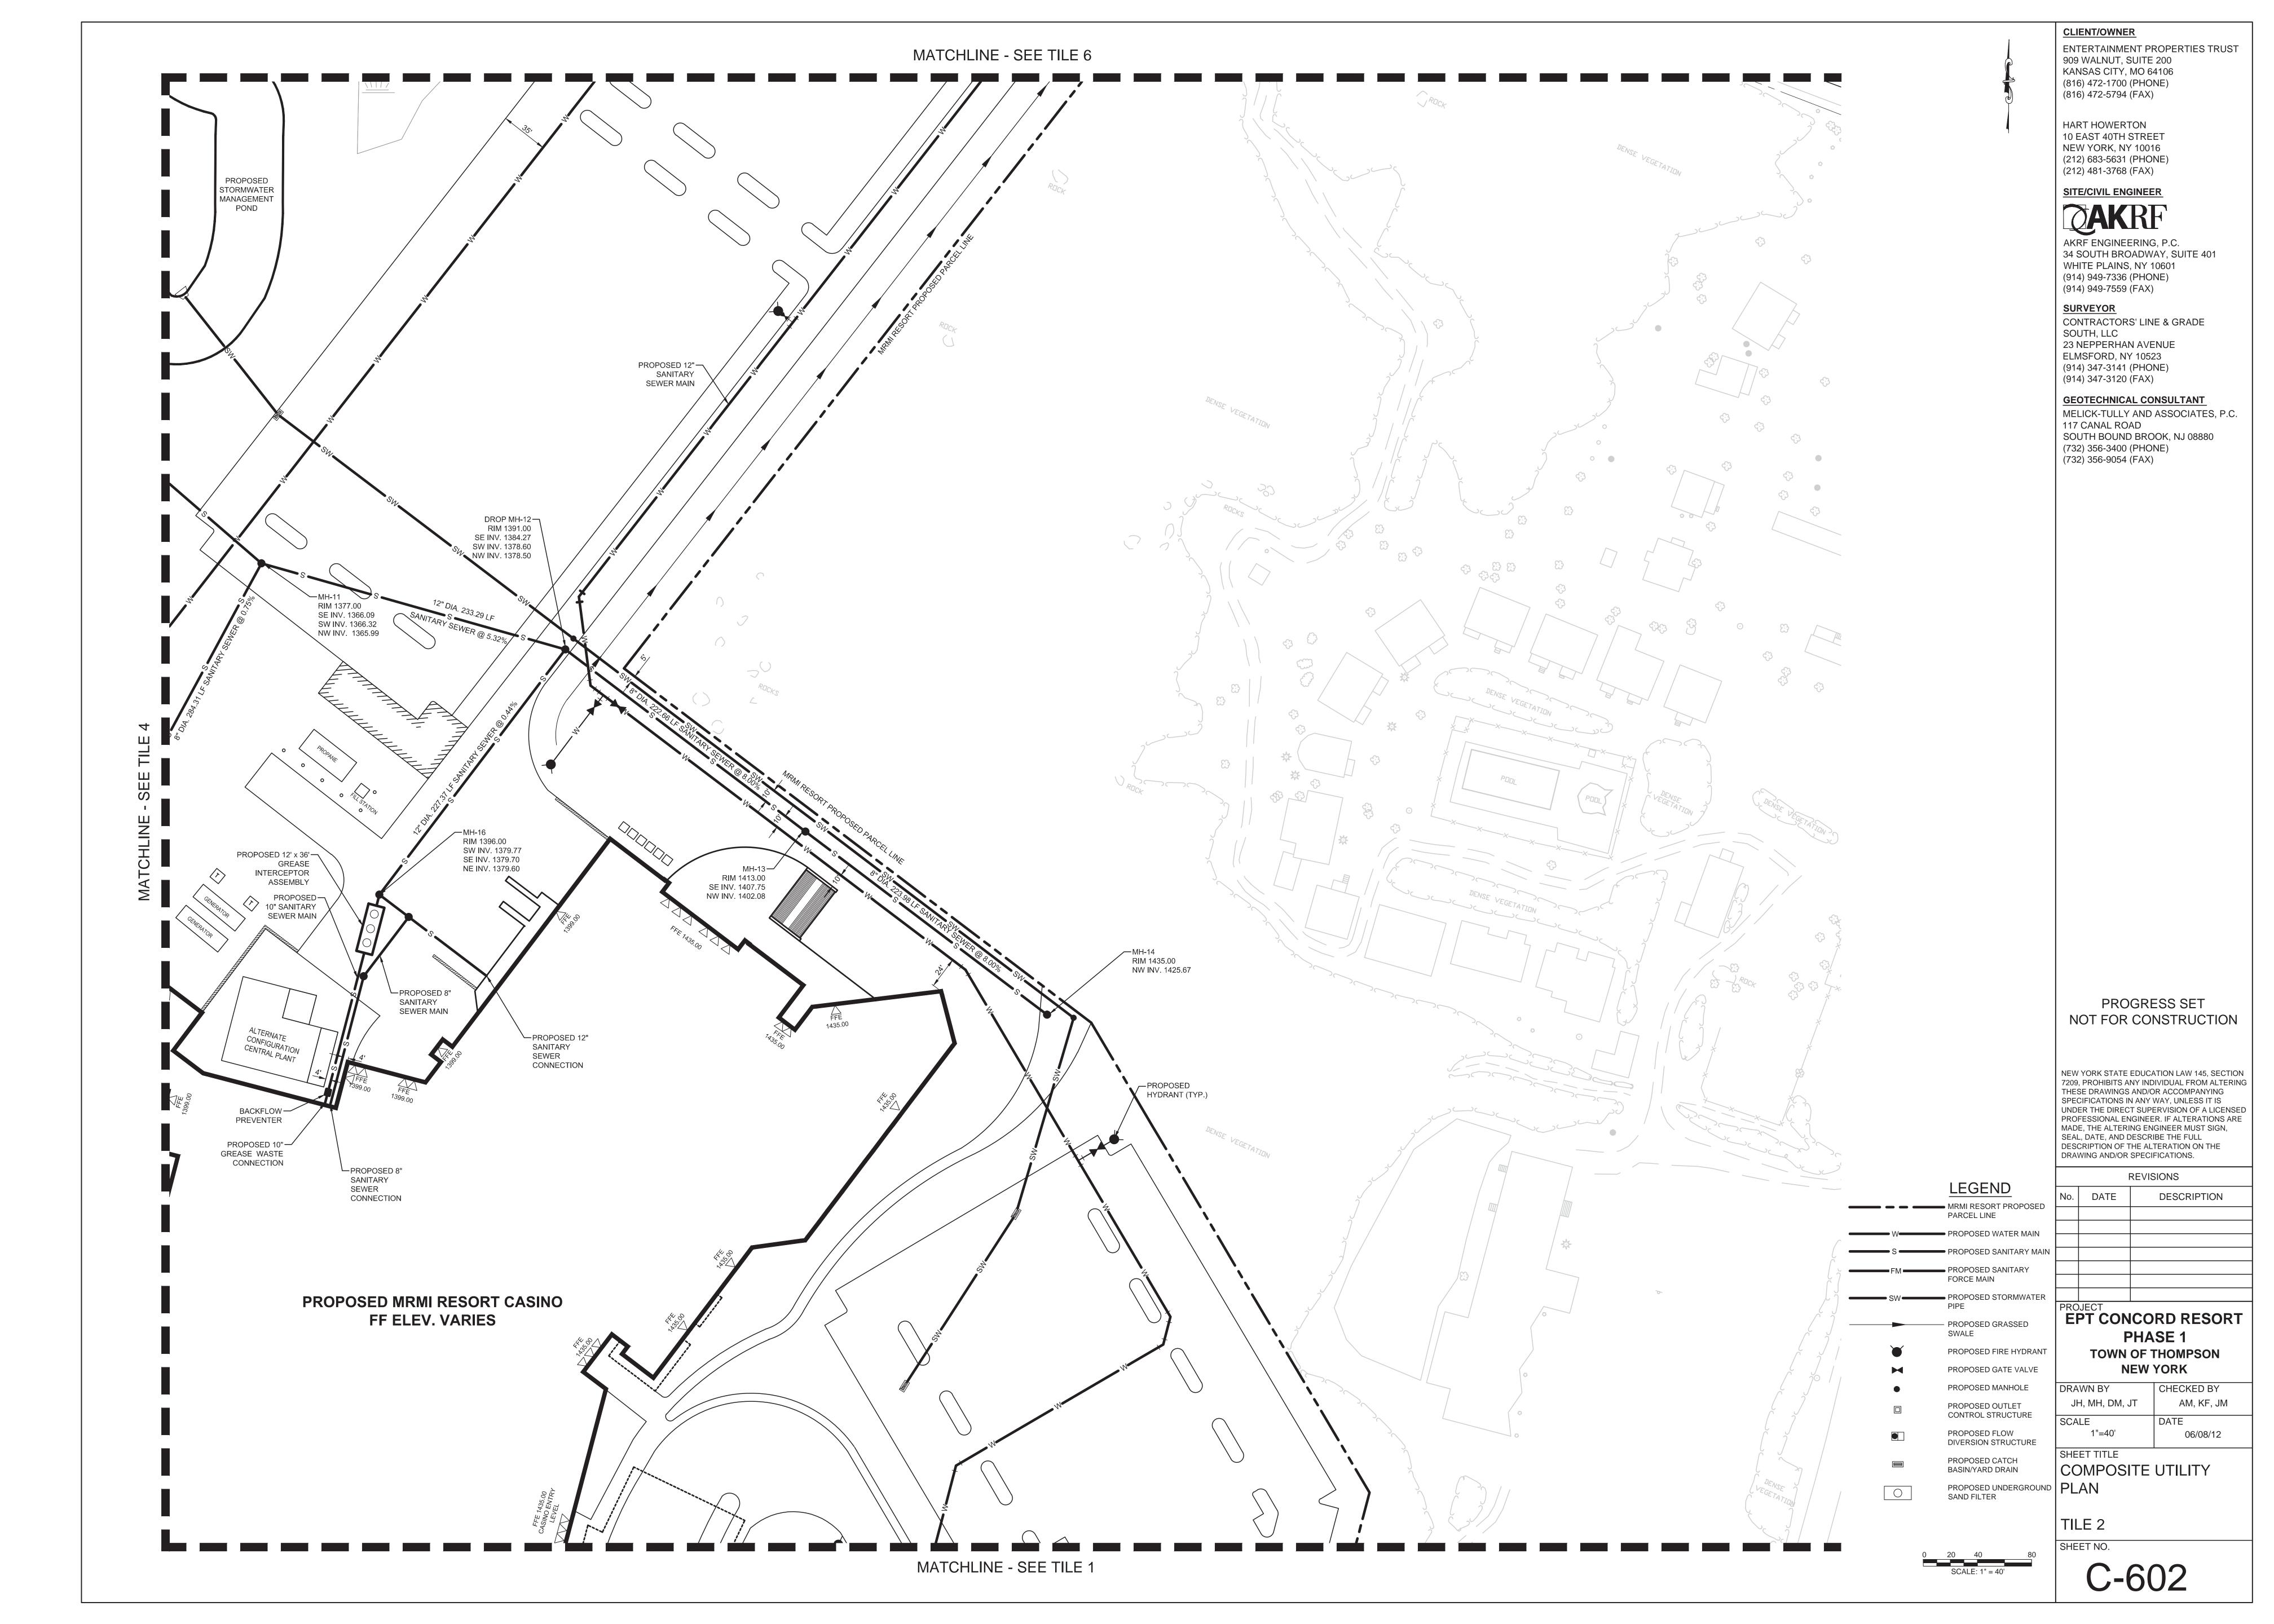

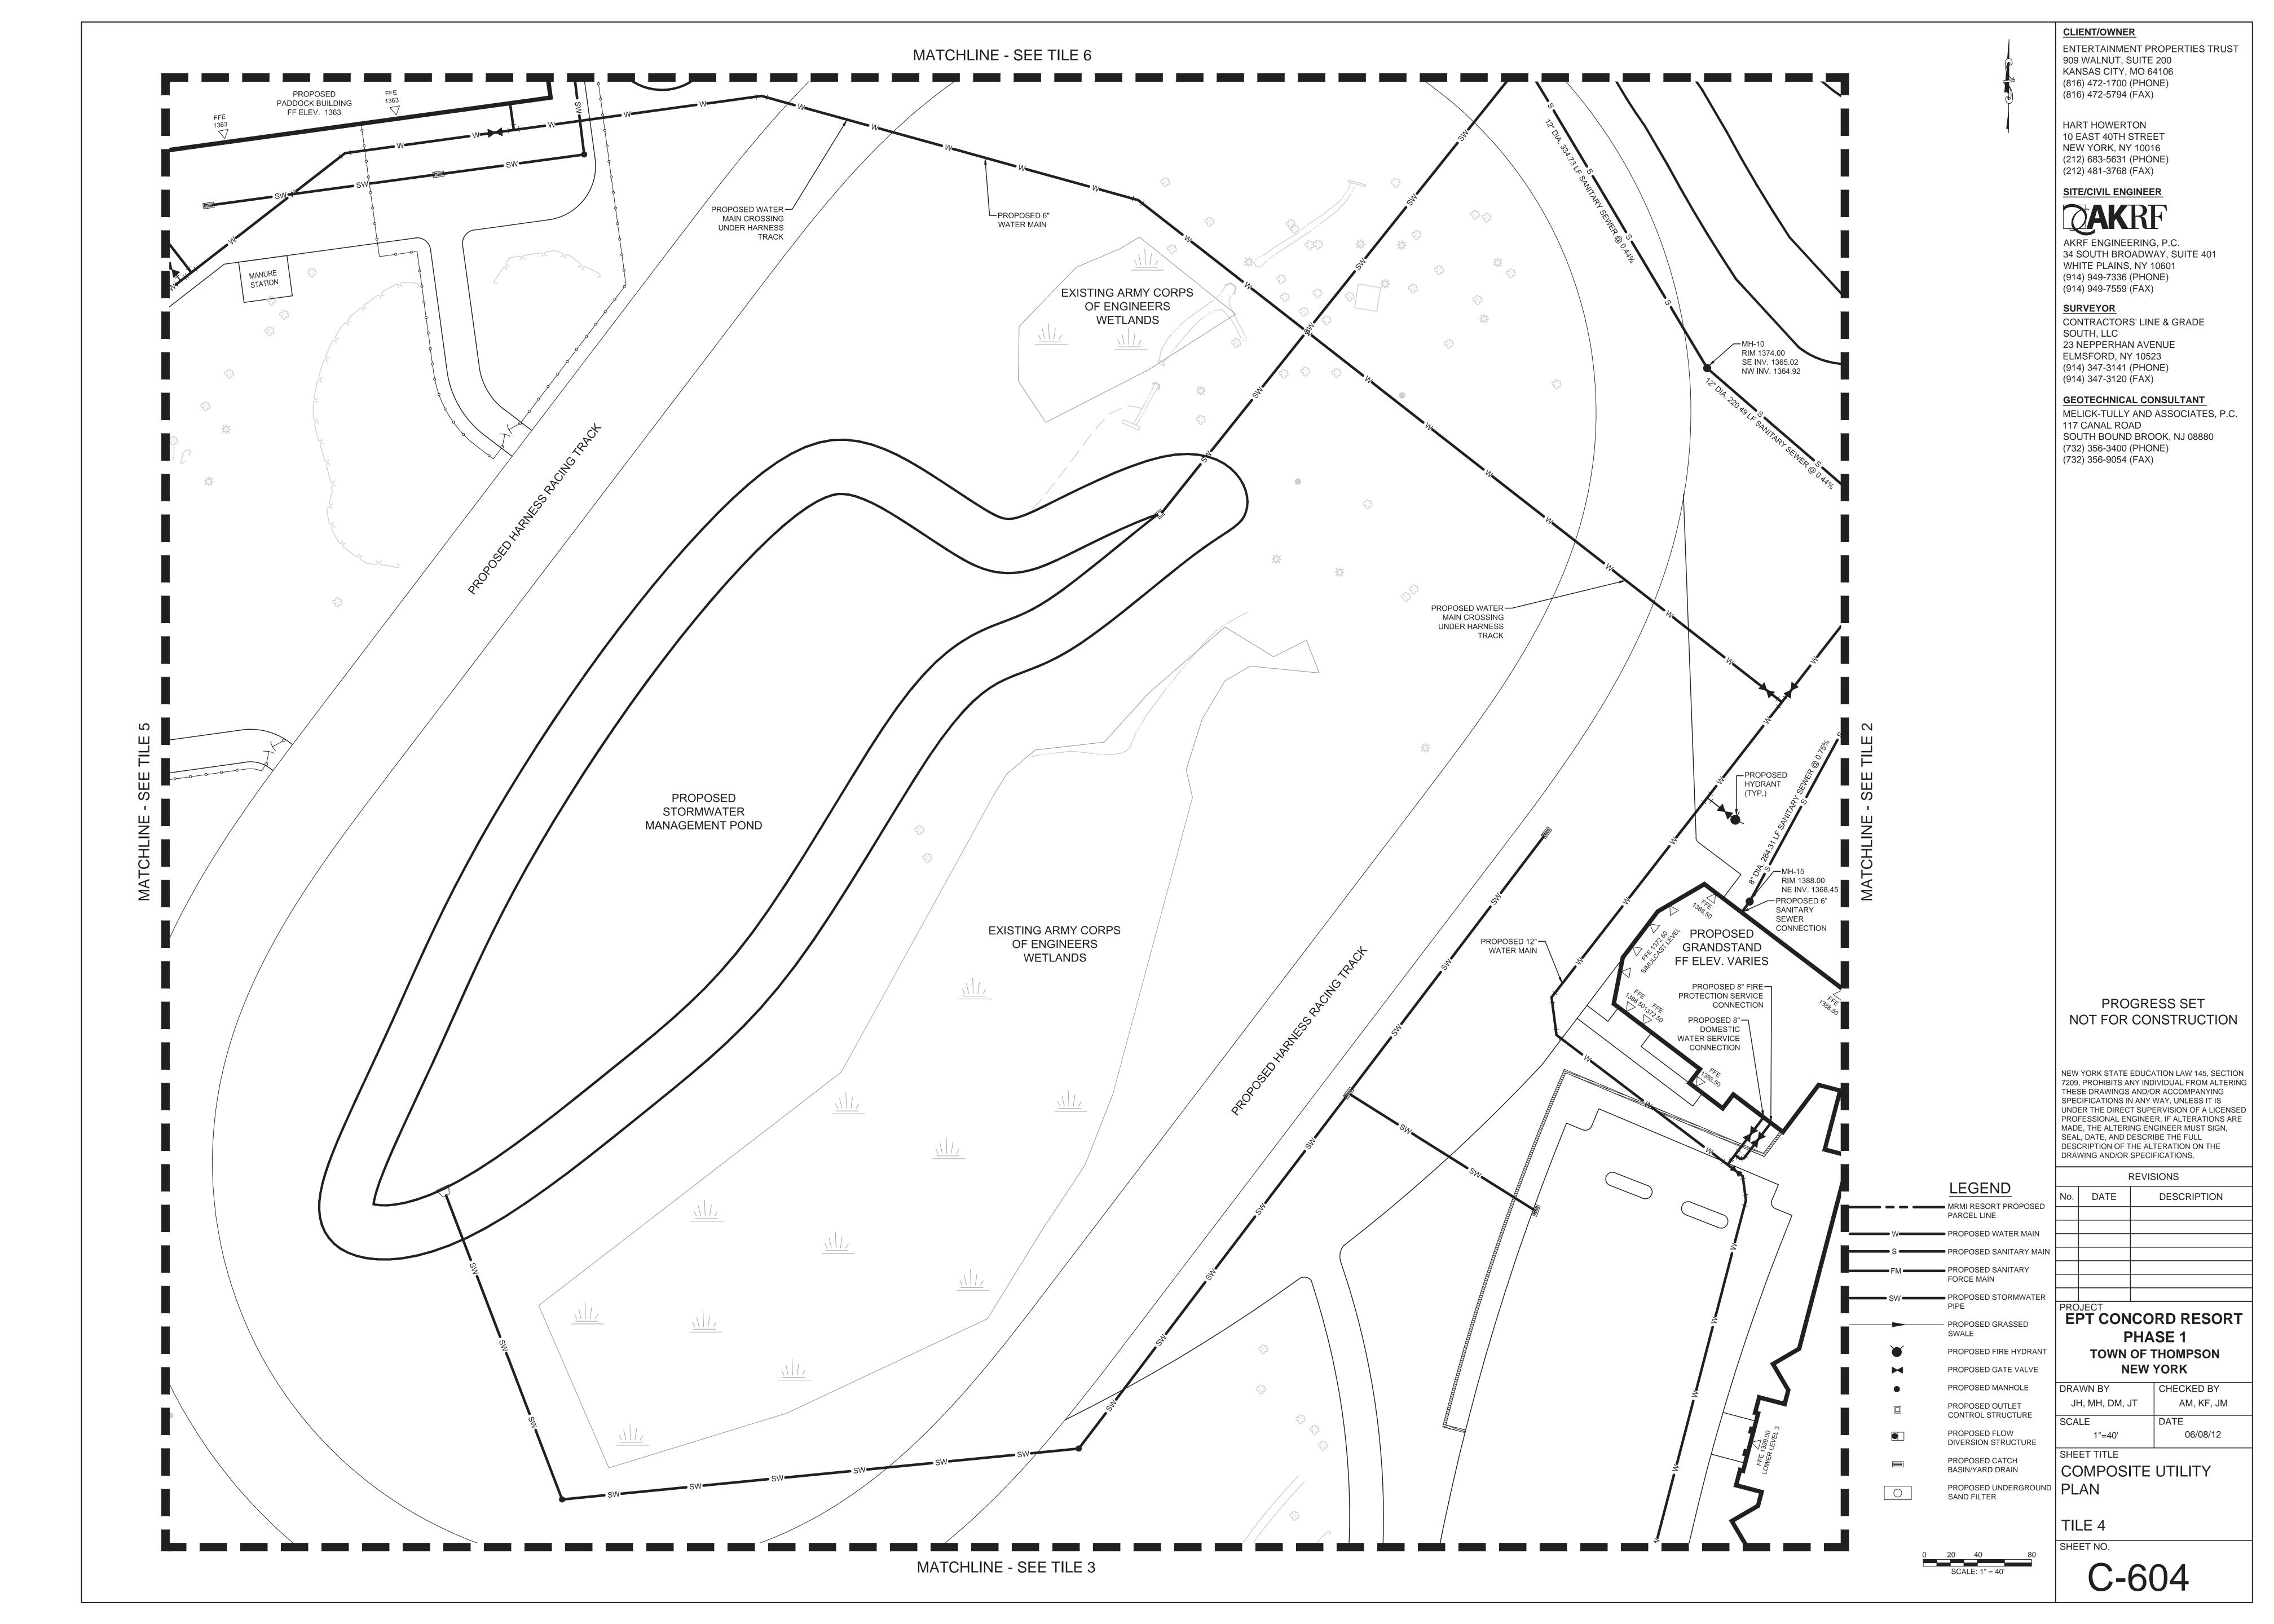

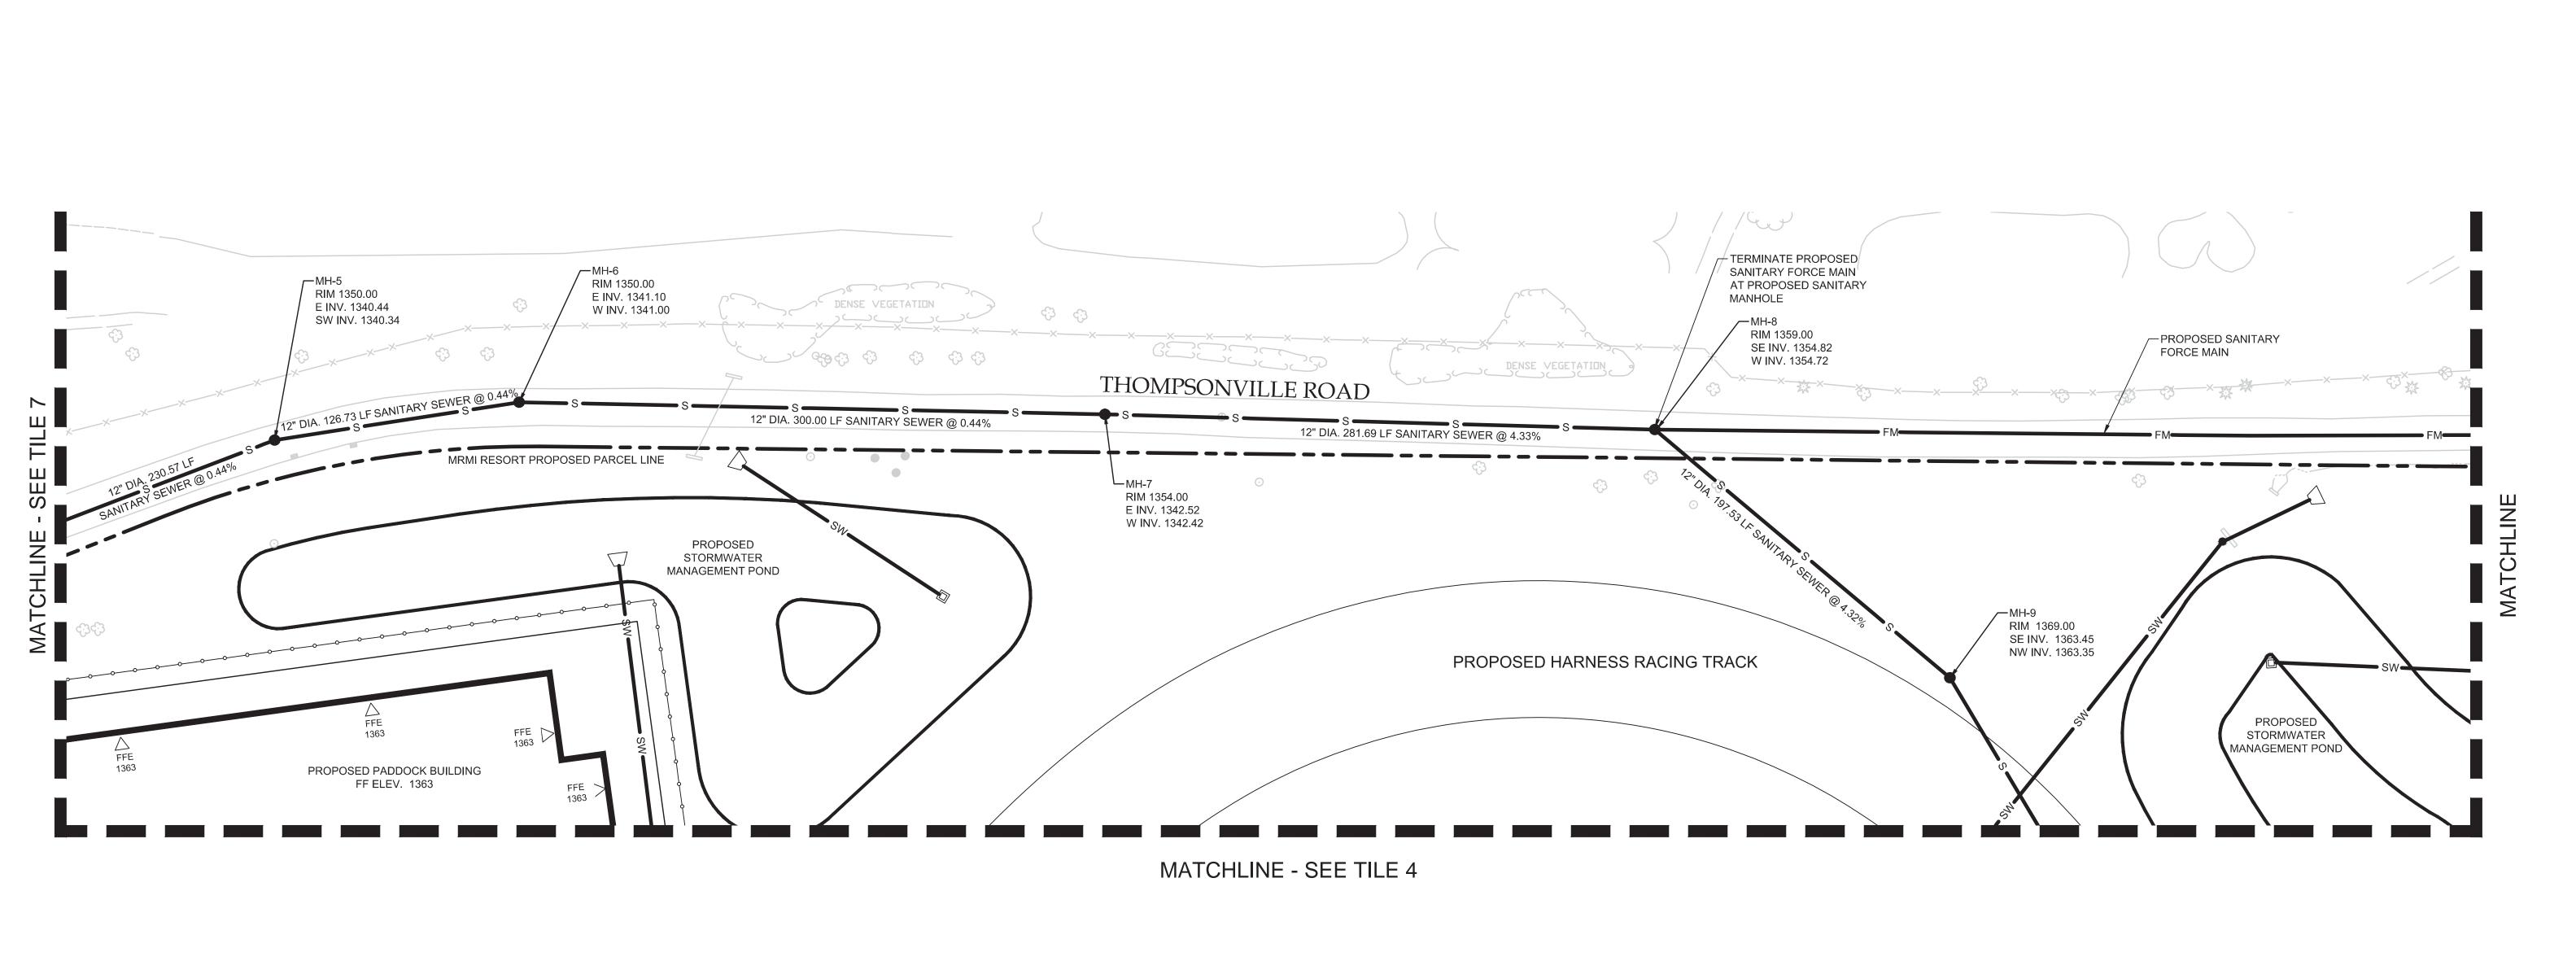

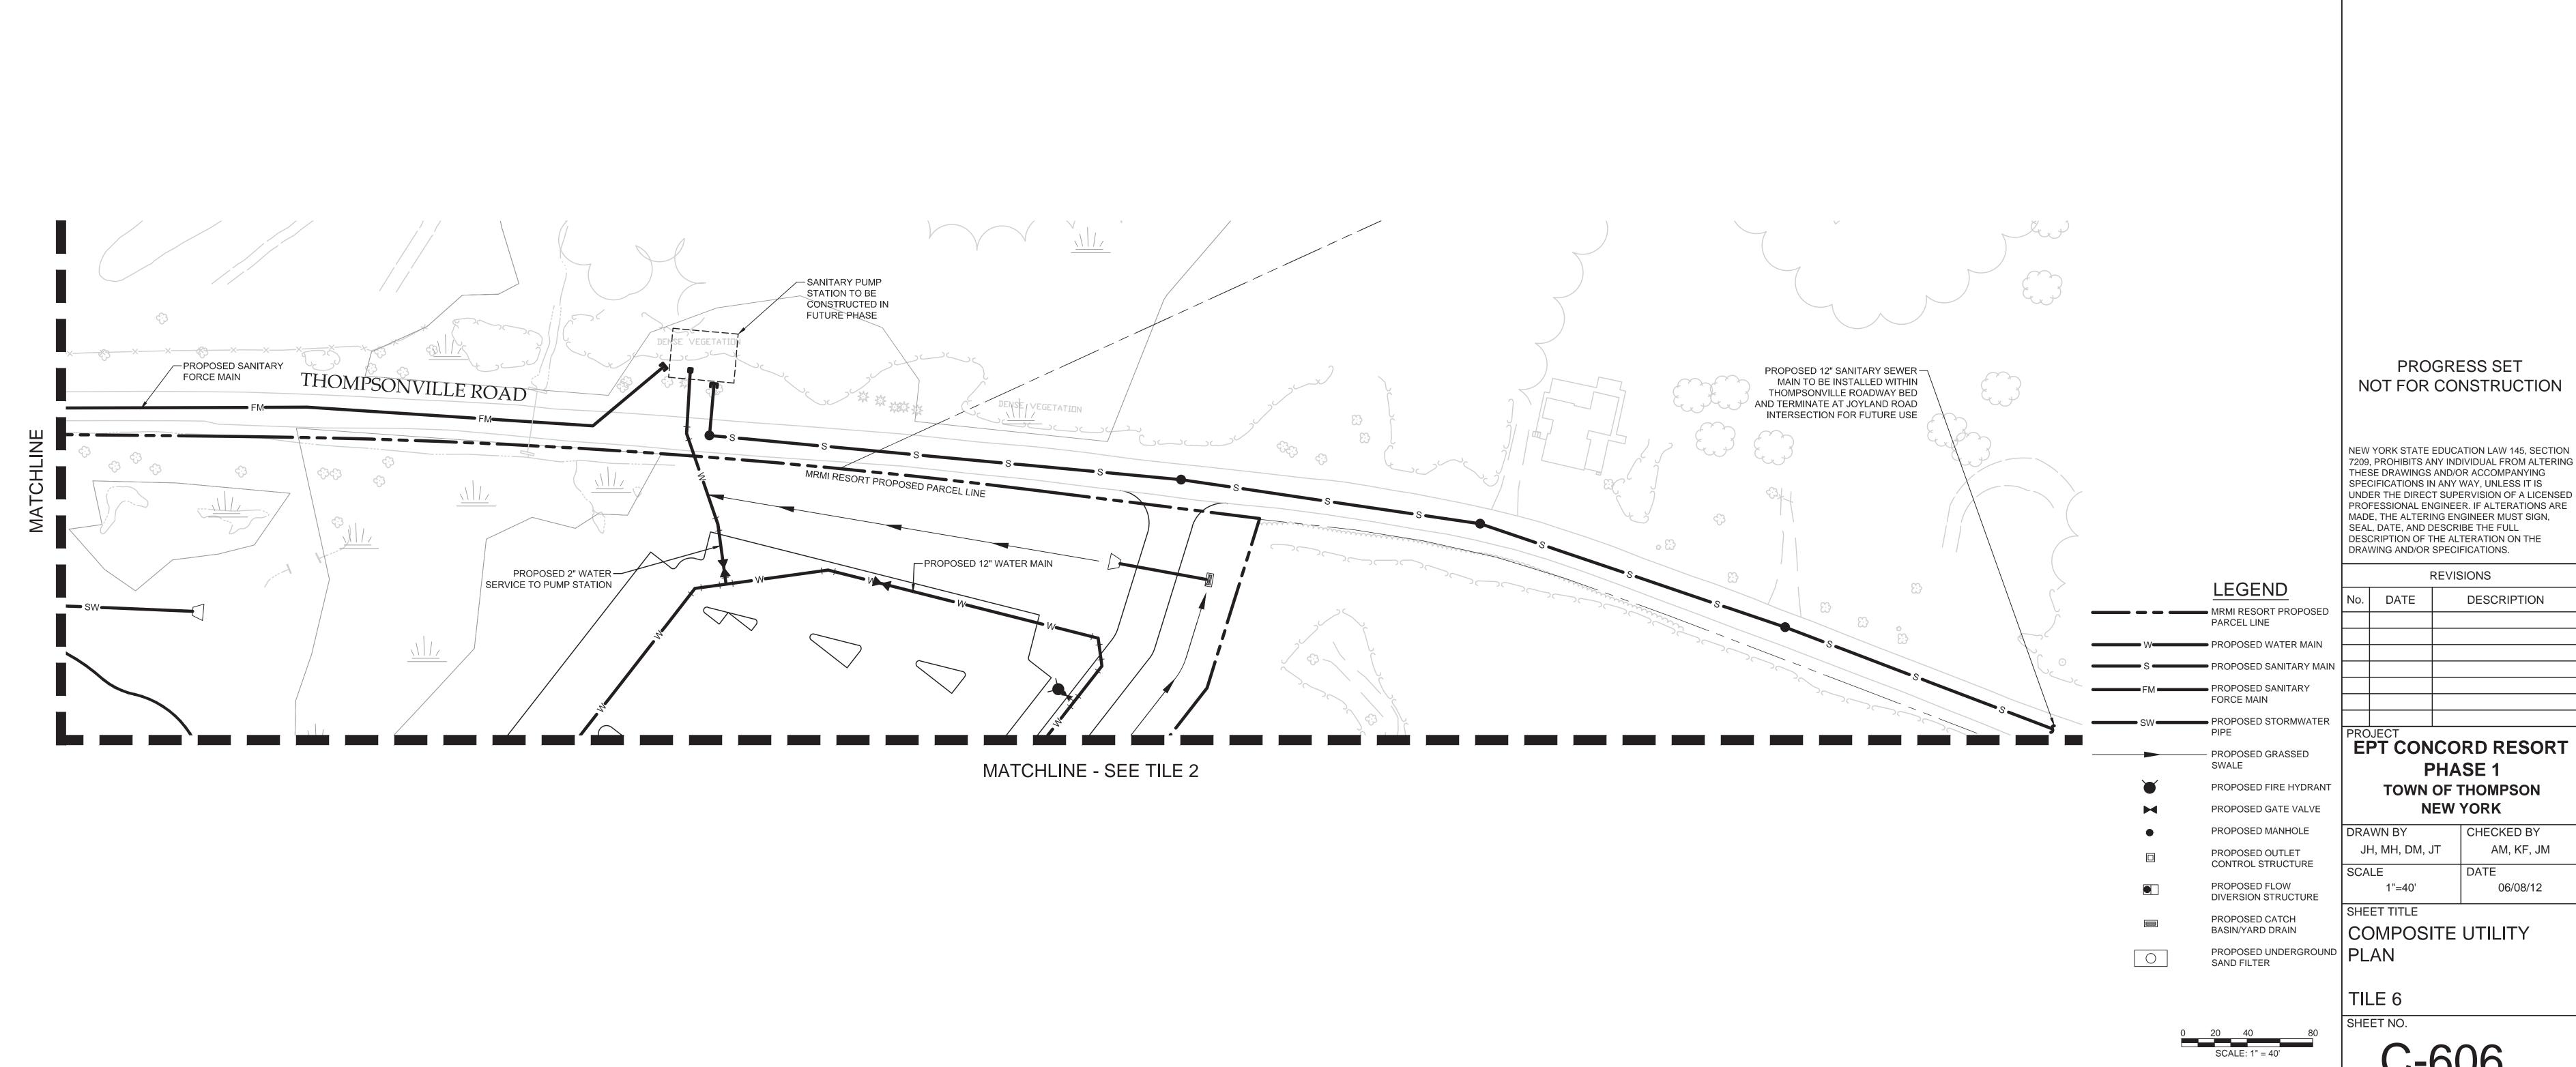

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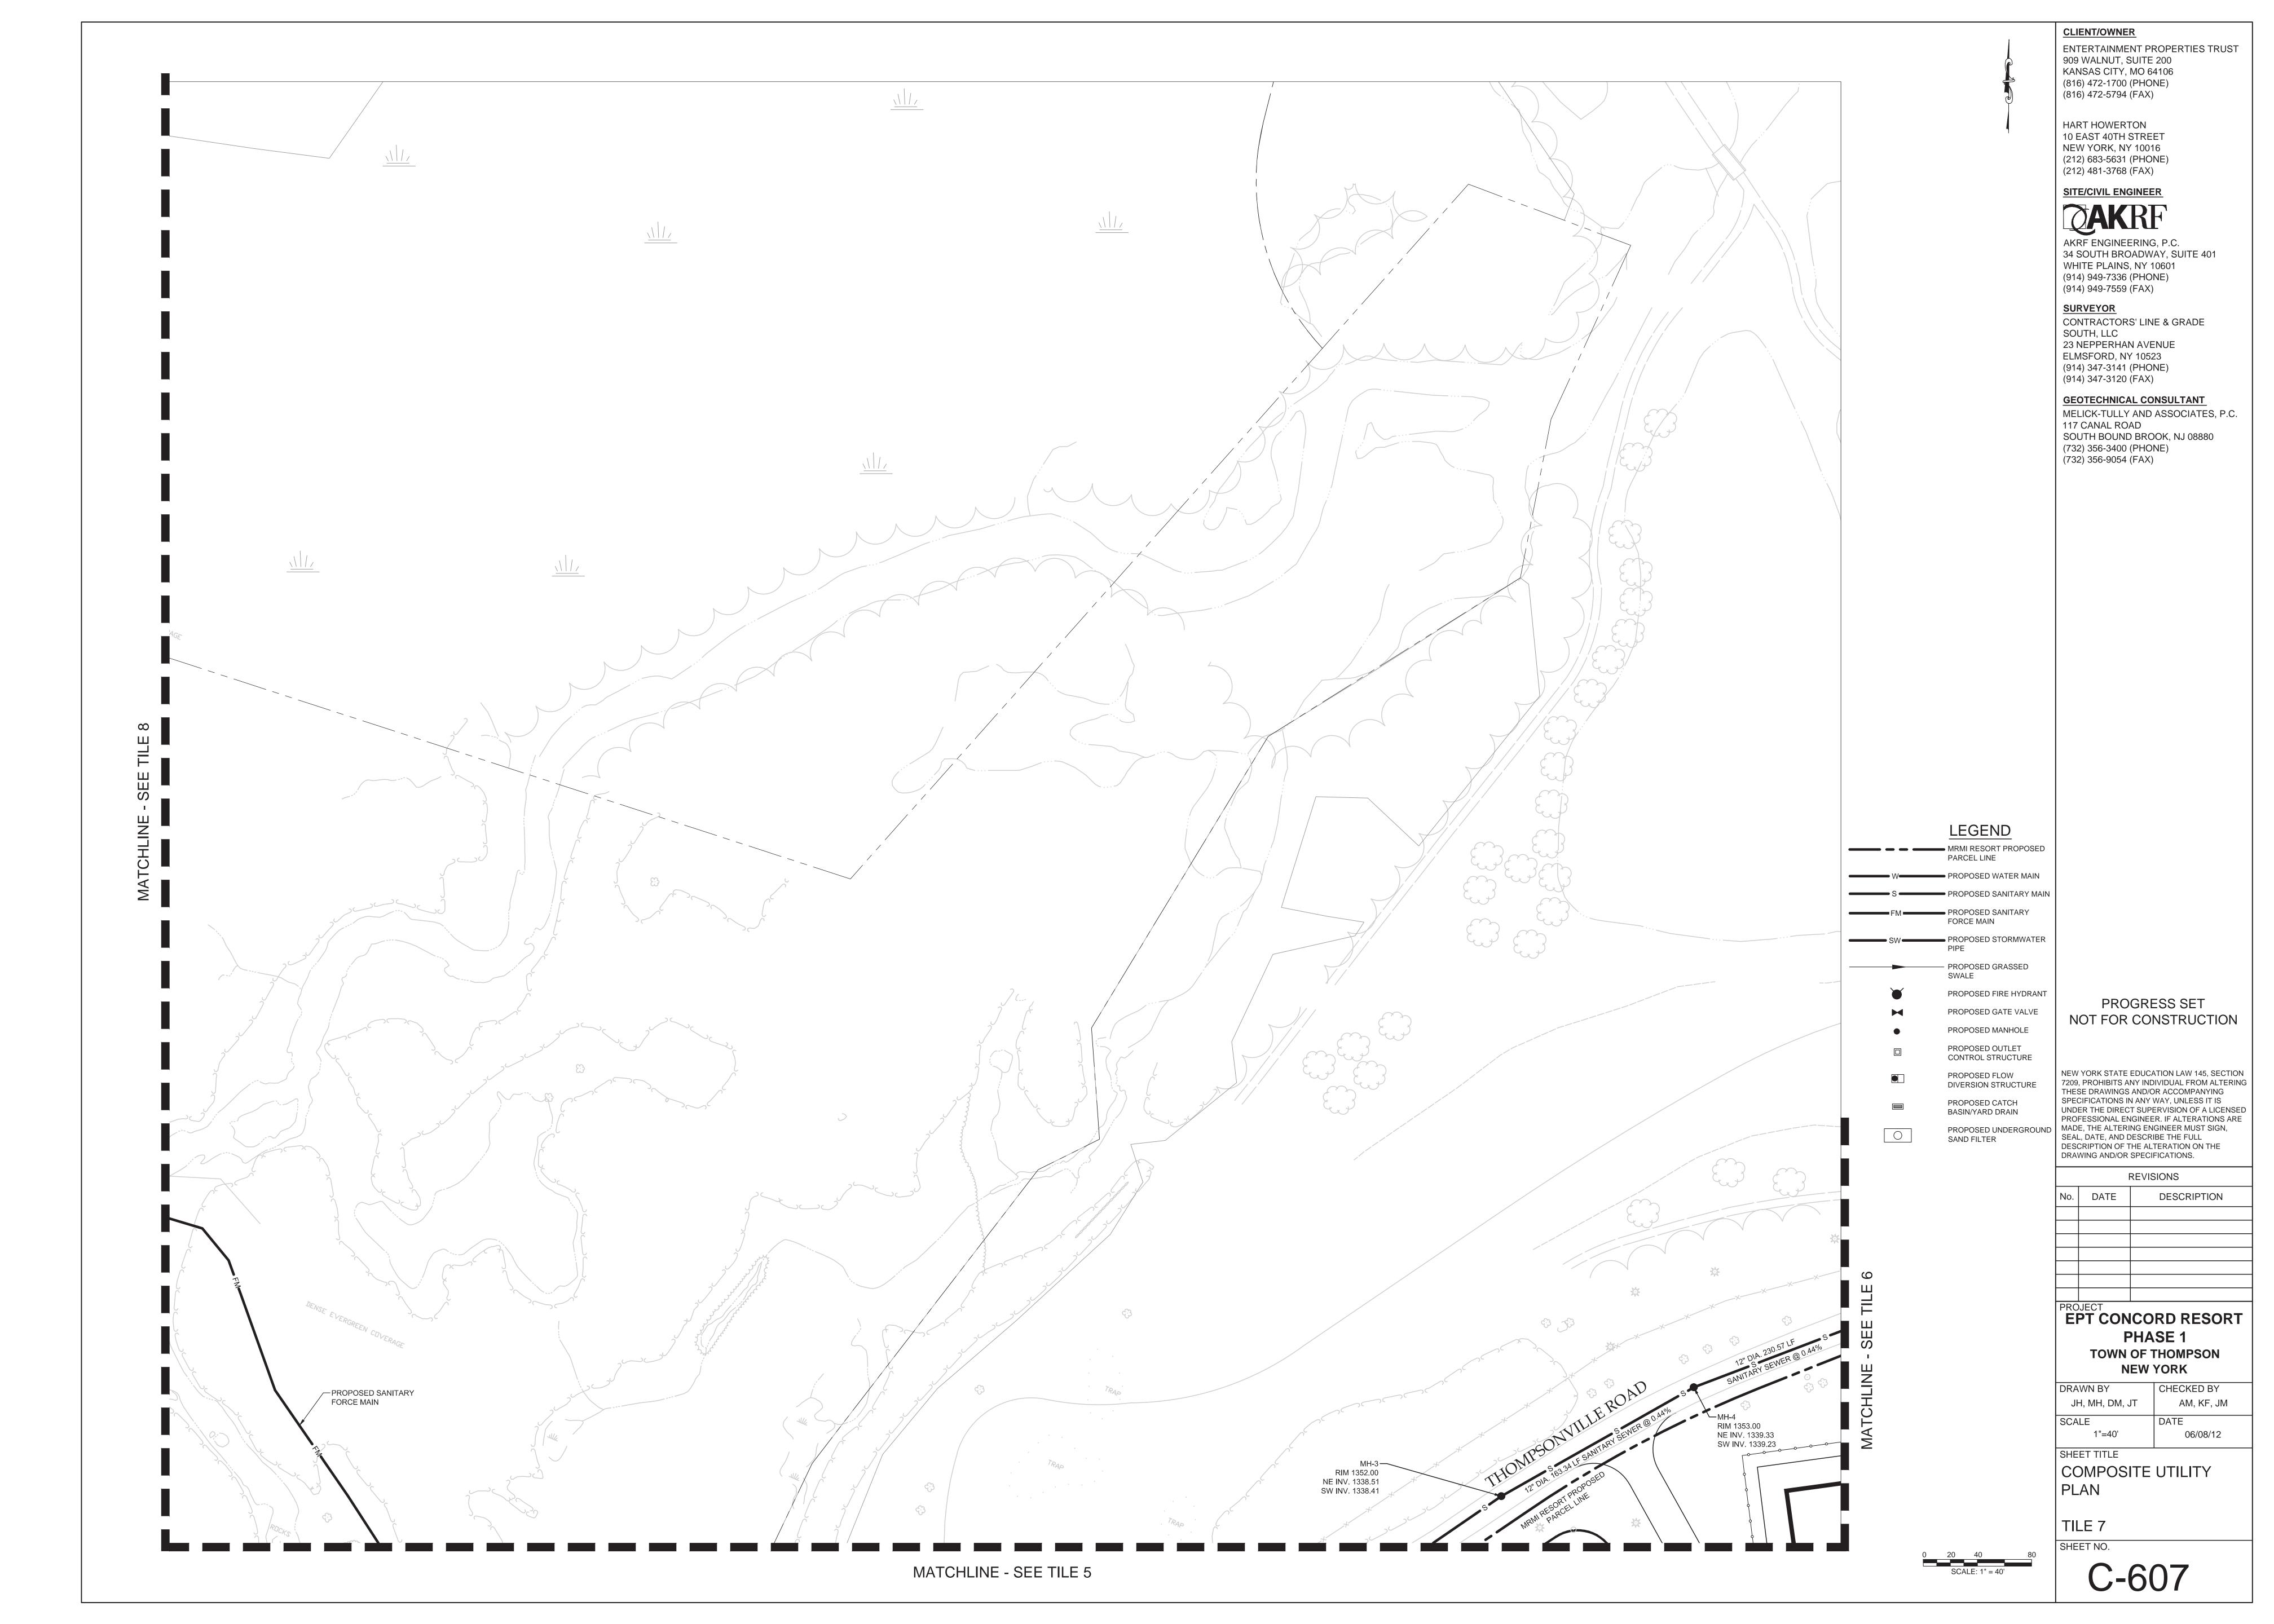
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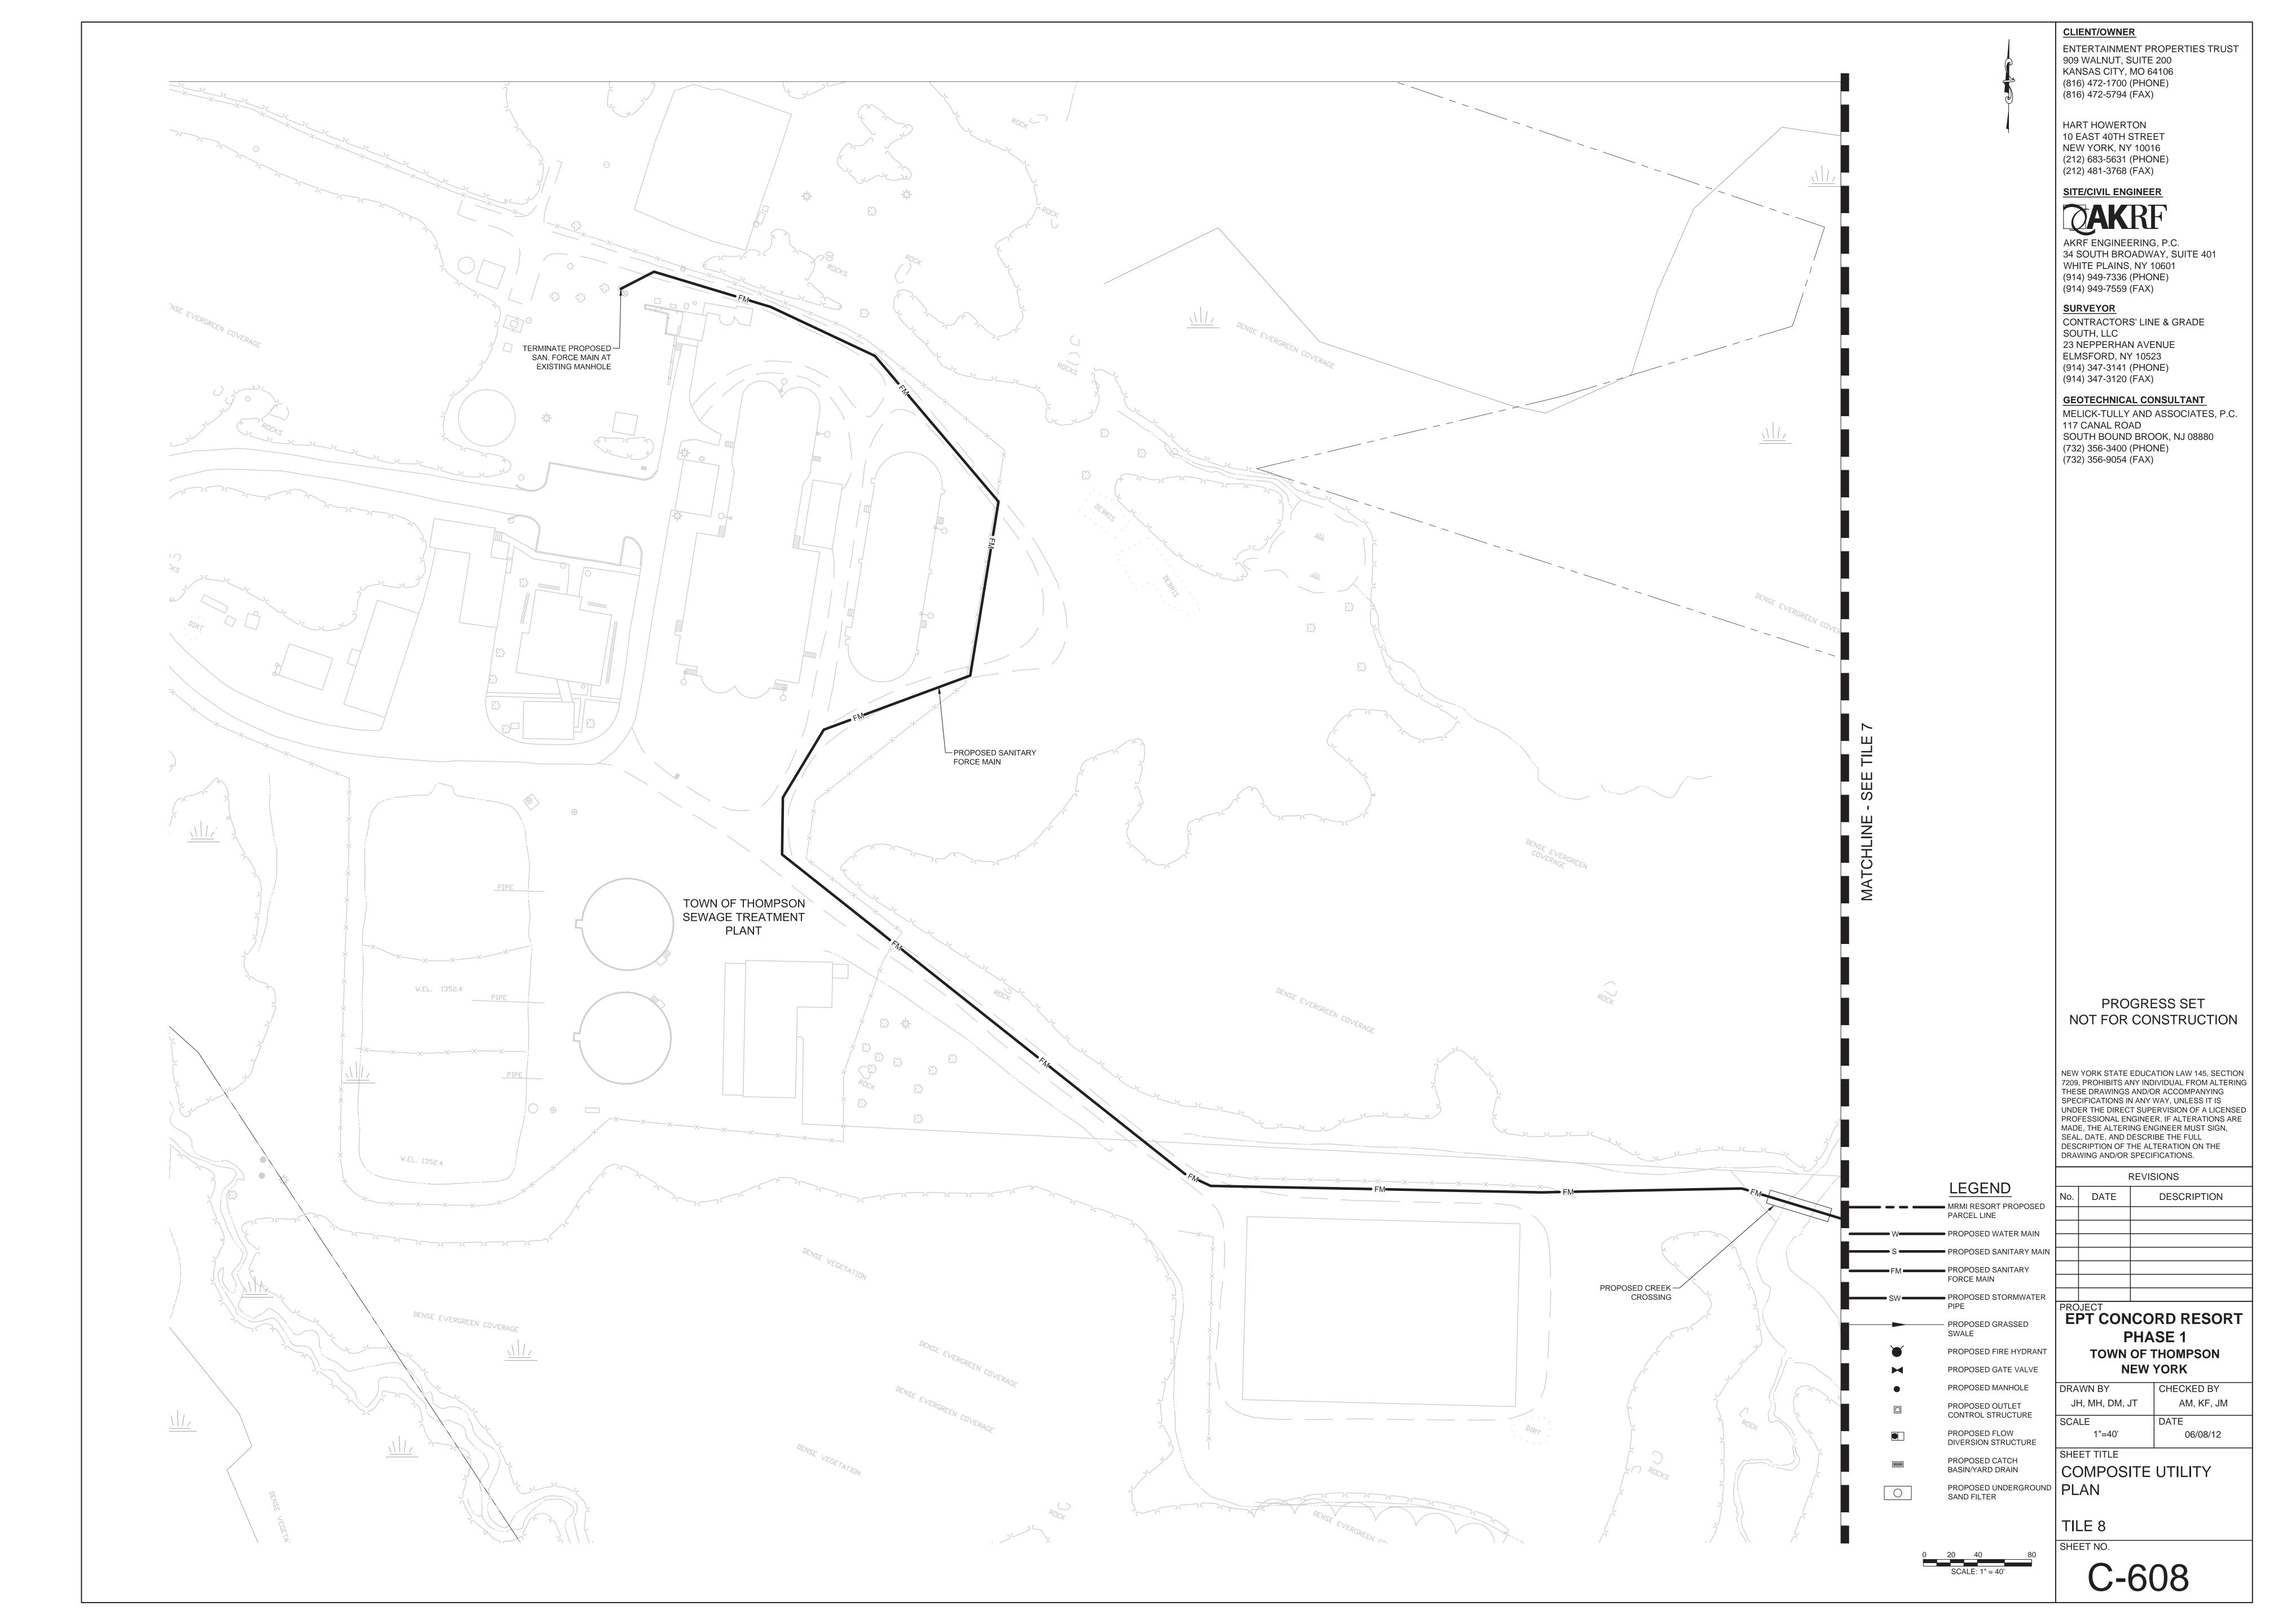
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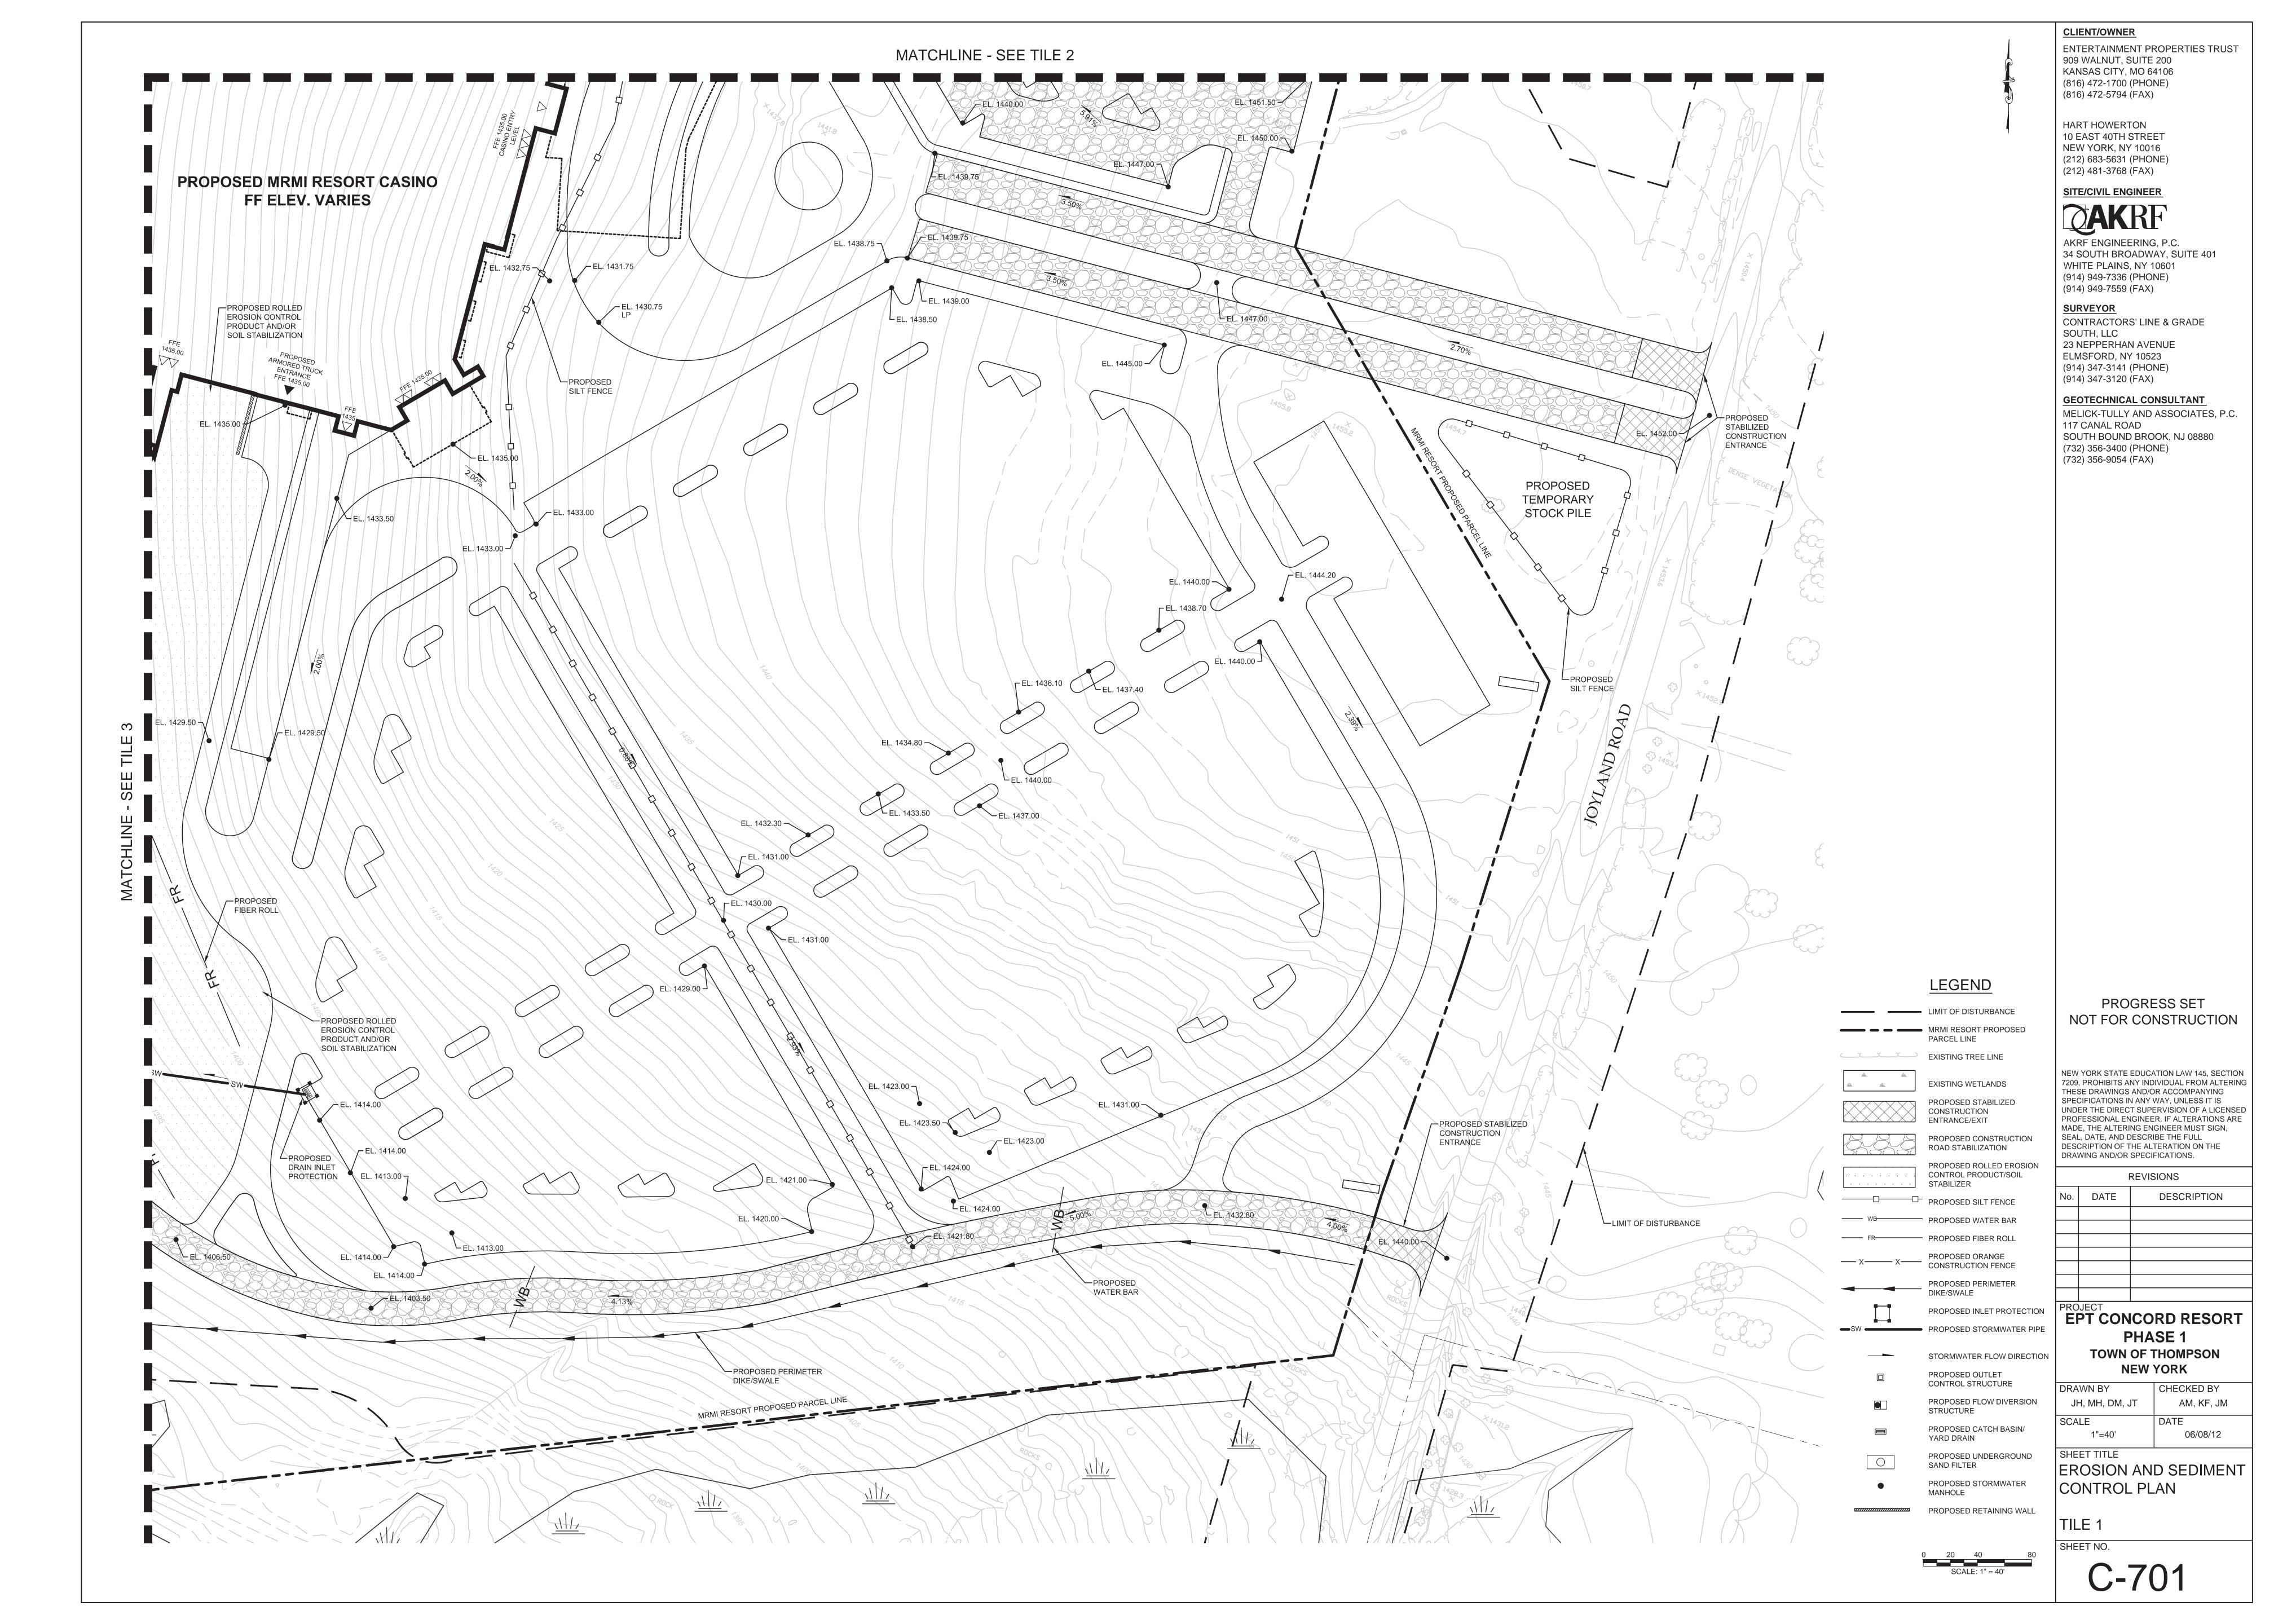
GEOTECHNICAL CONSULTANT


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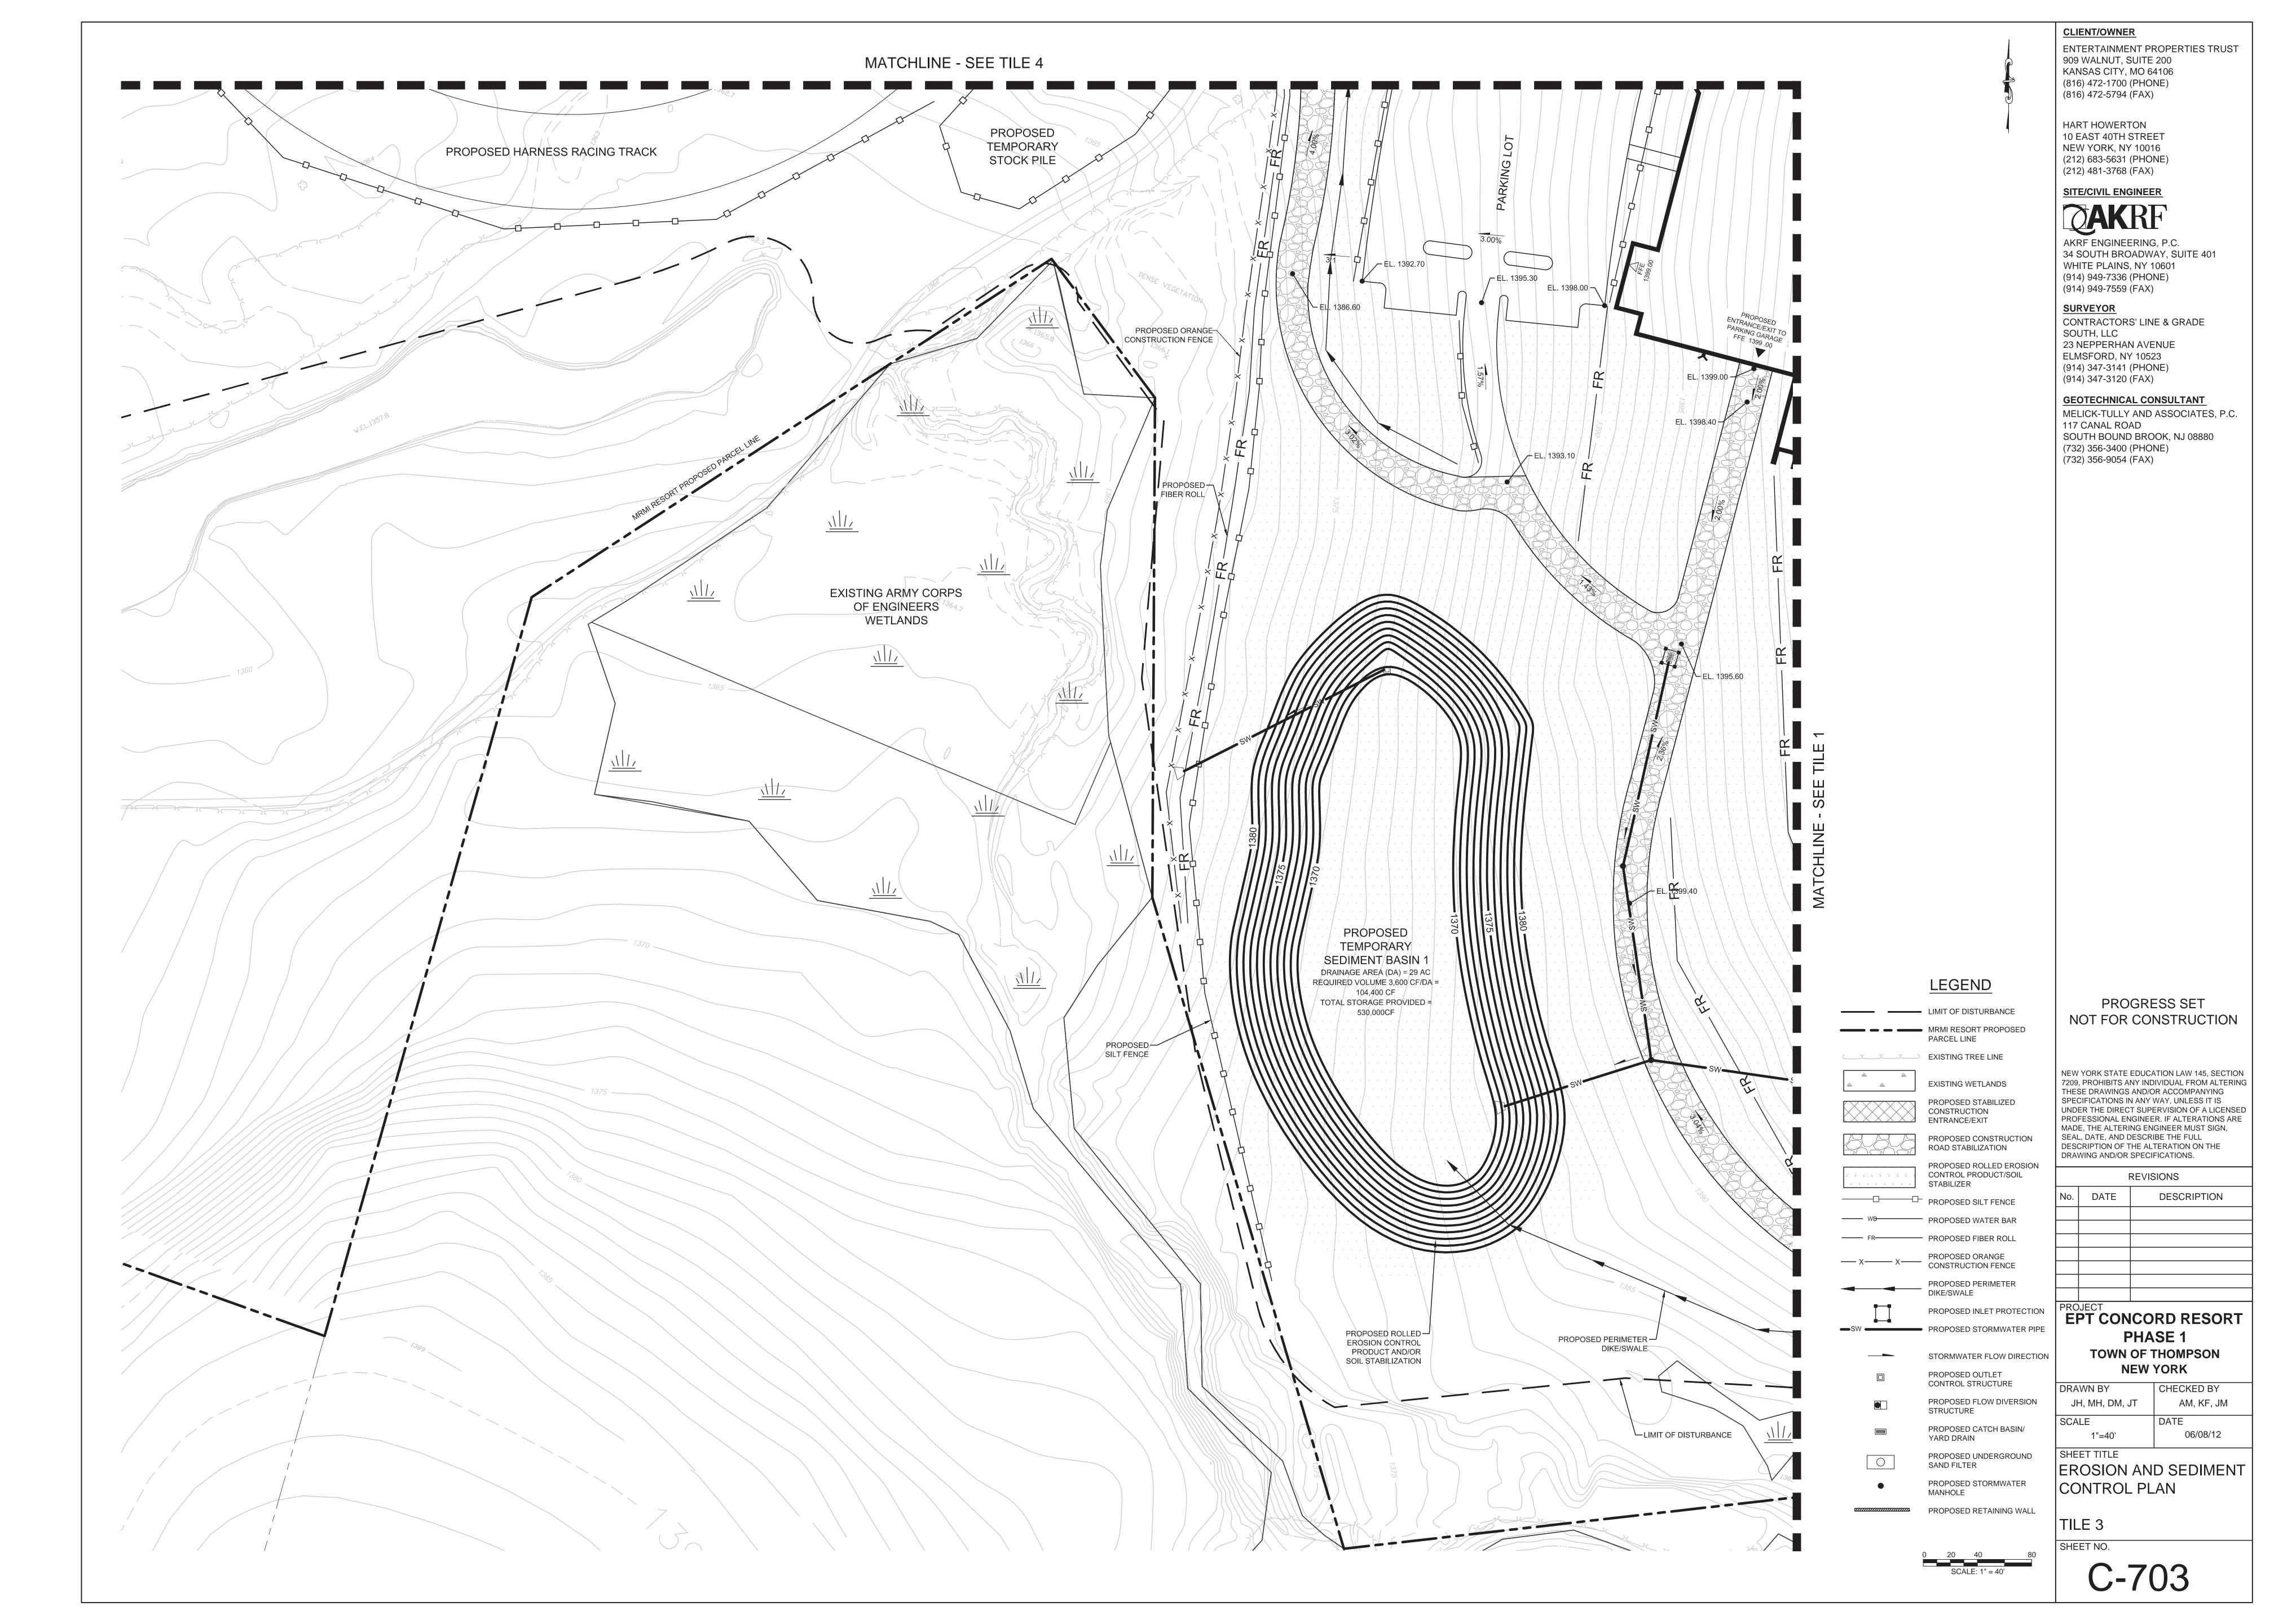
	REVISIONS					
	No.	DATE	DESCRIPTION			
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	EPT CONCORD RESORT					
-	PHASE 1 TOWN OF THOMPSON					
	NEW YORK					
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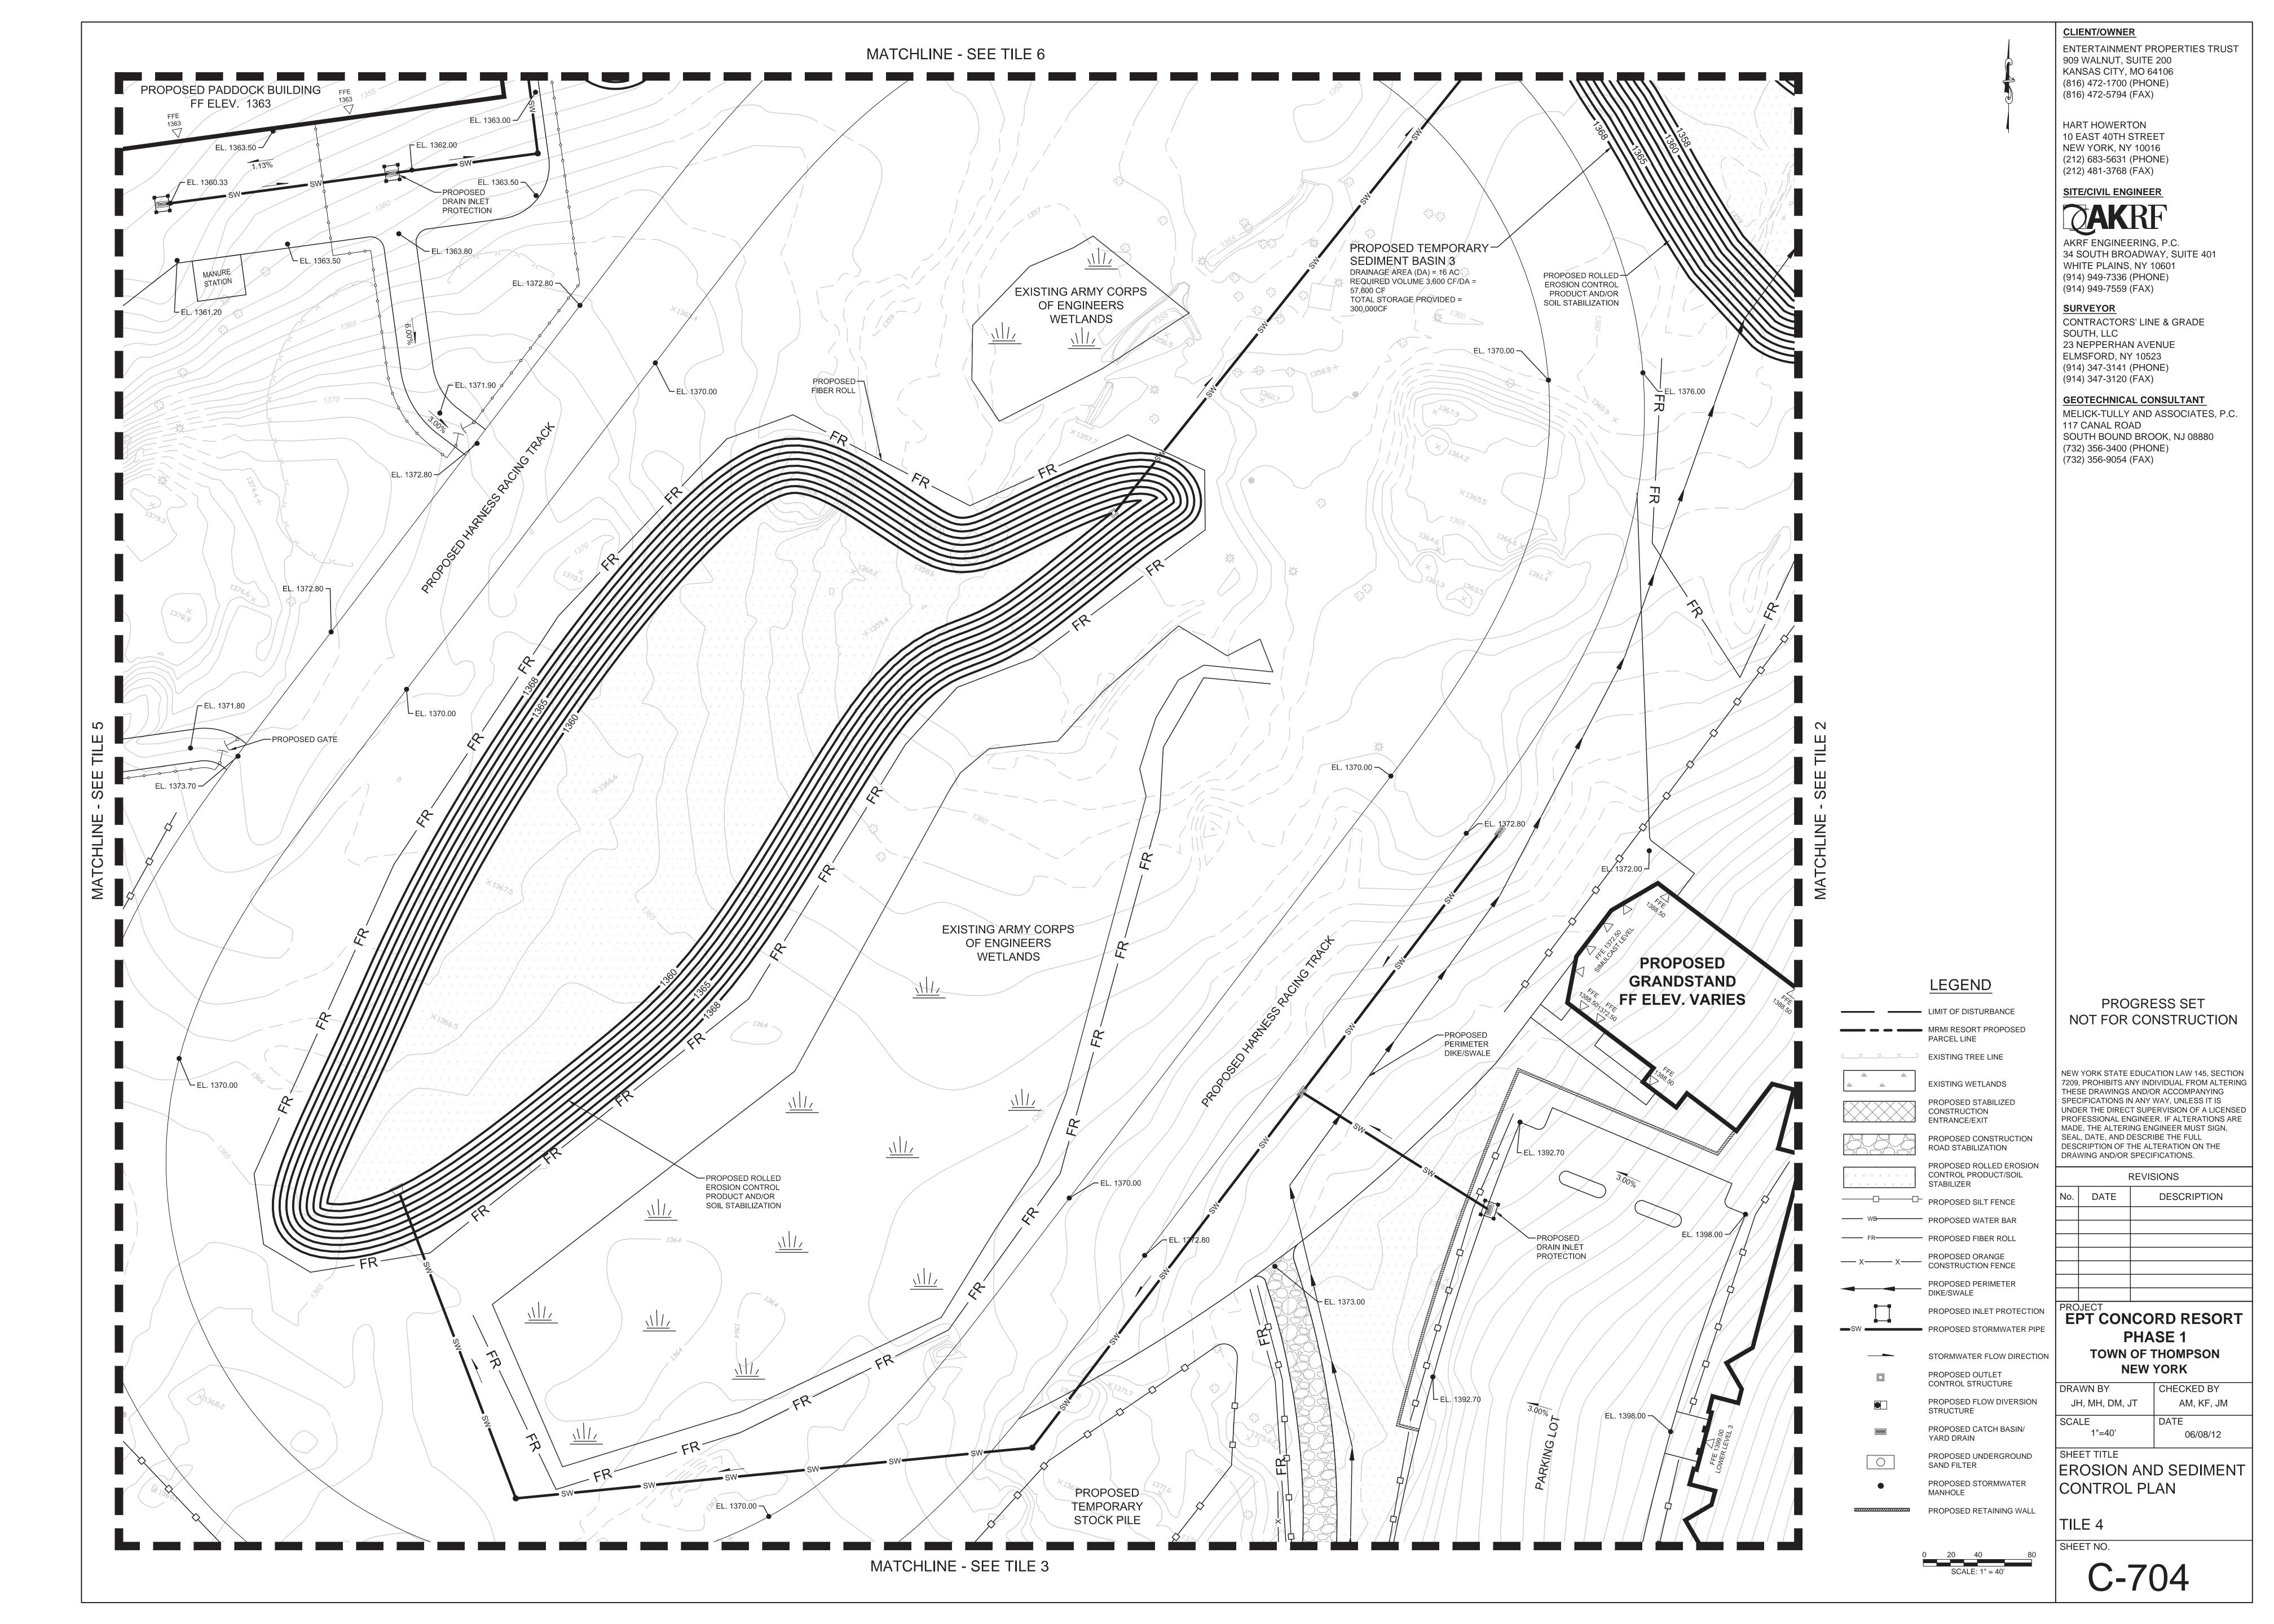













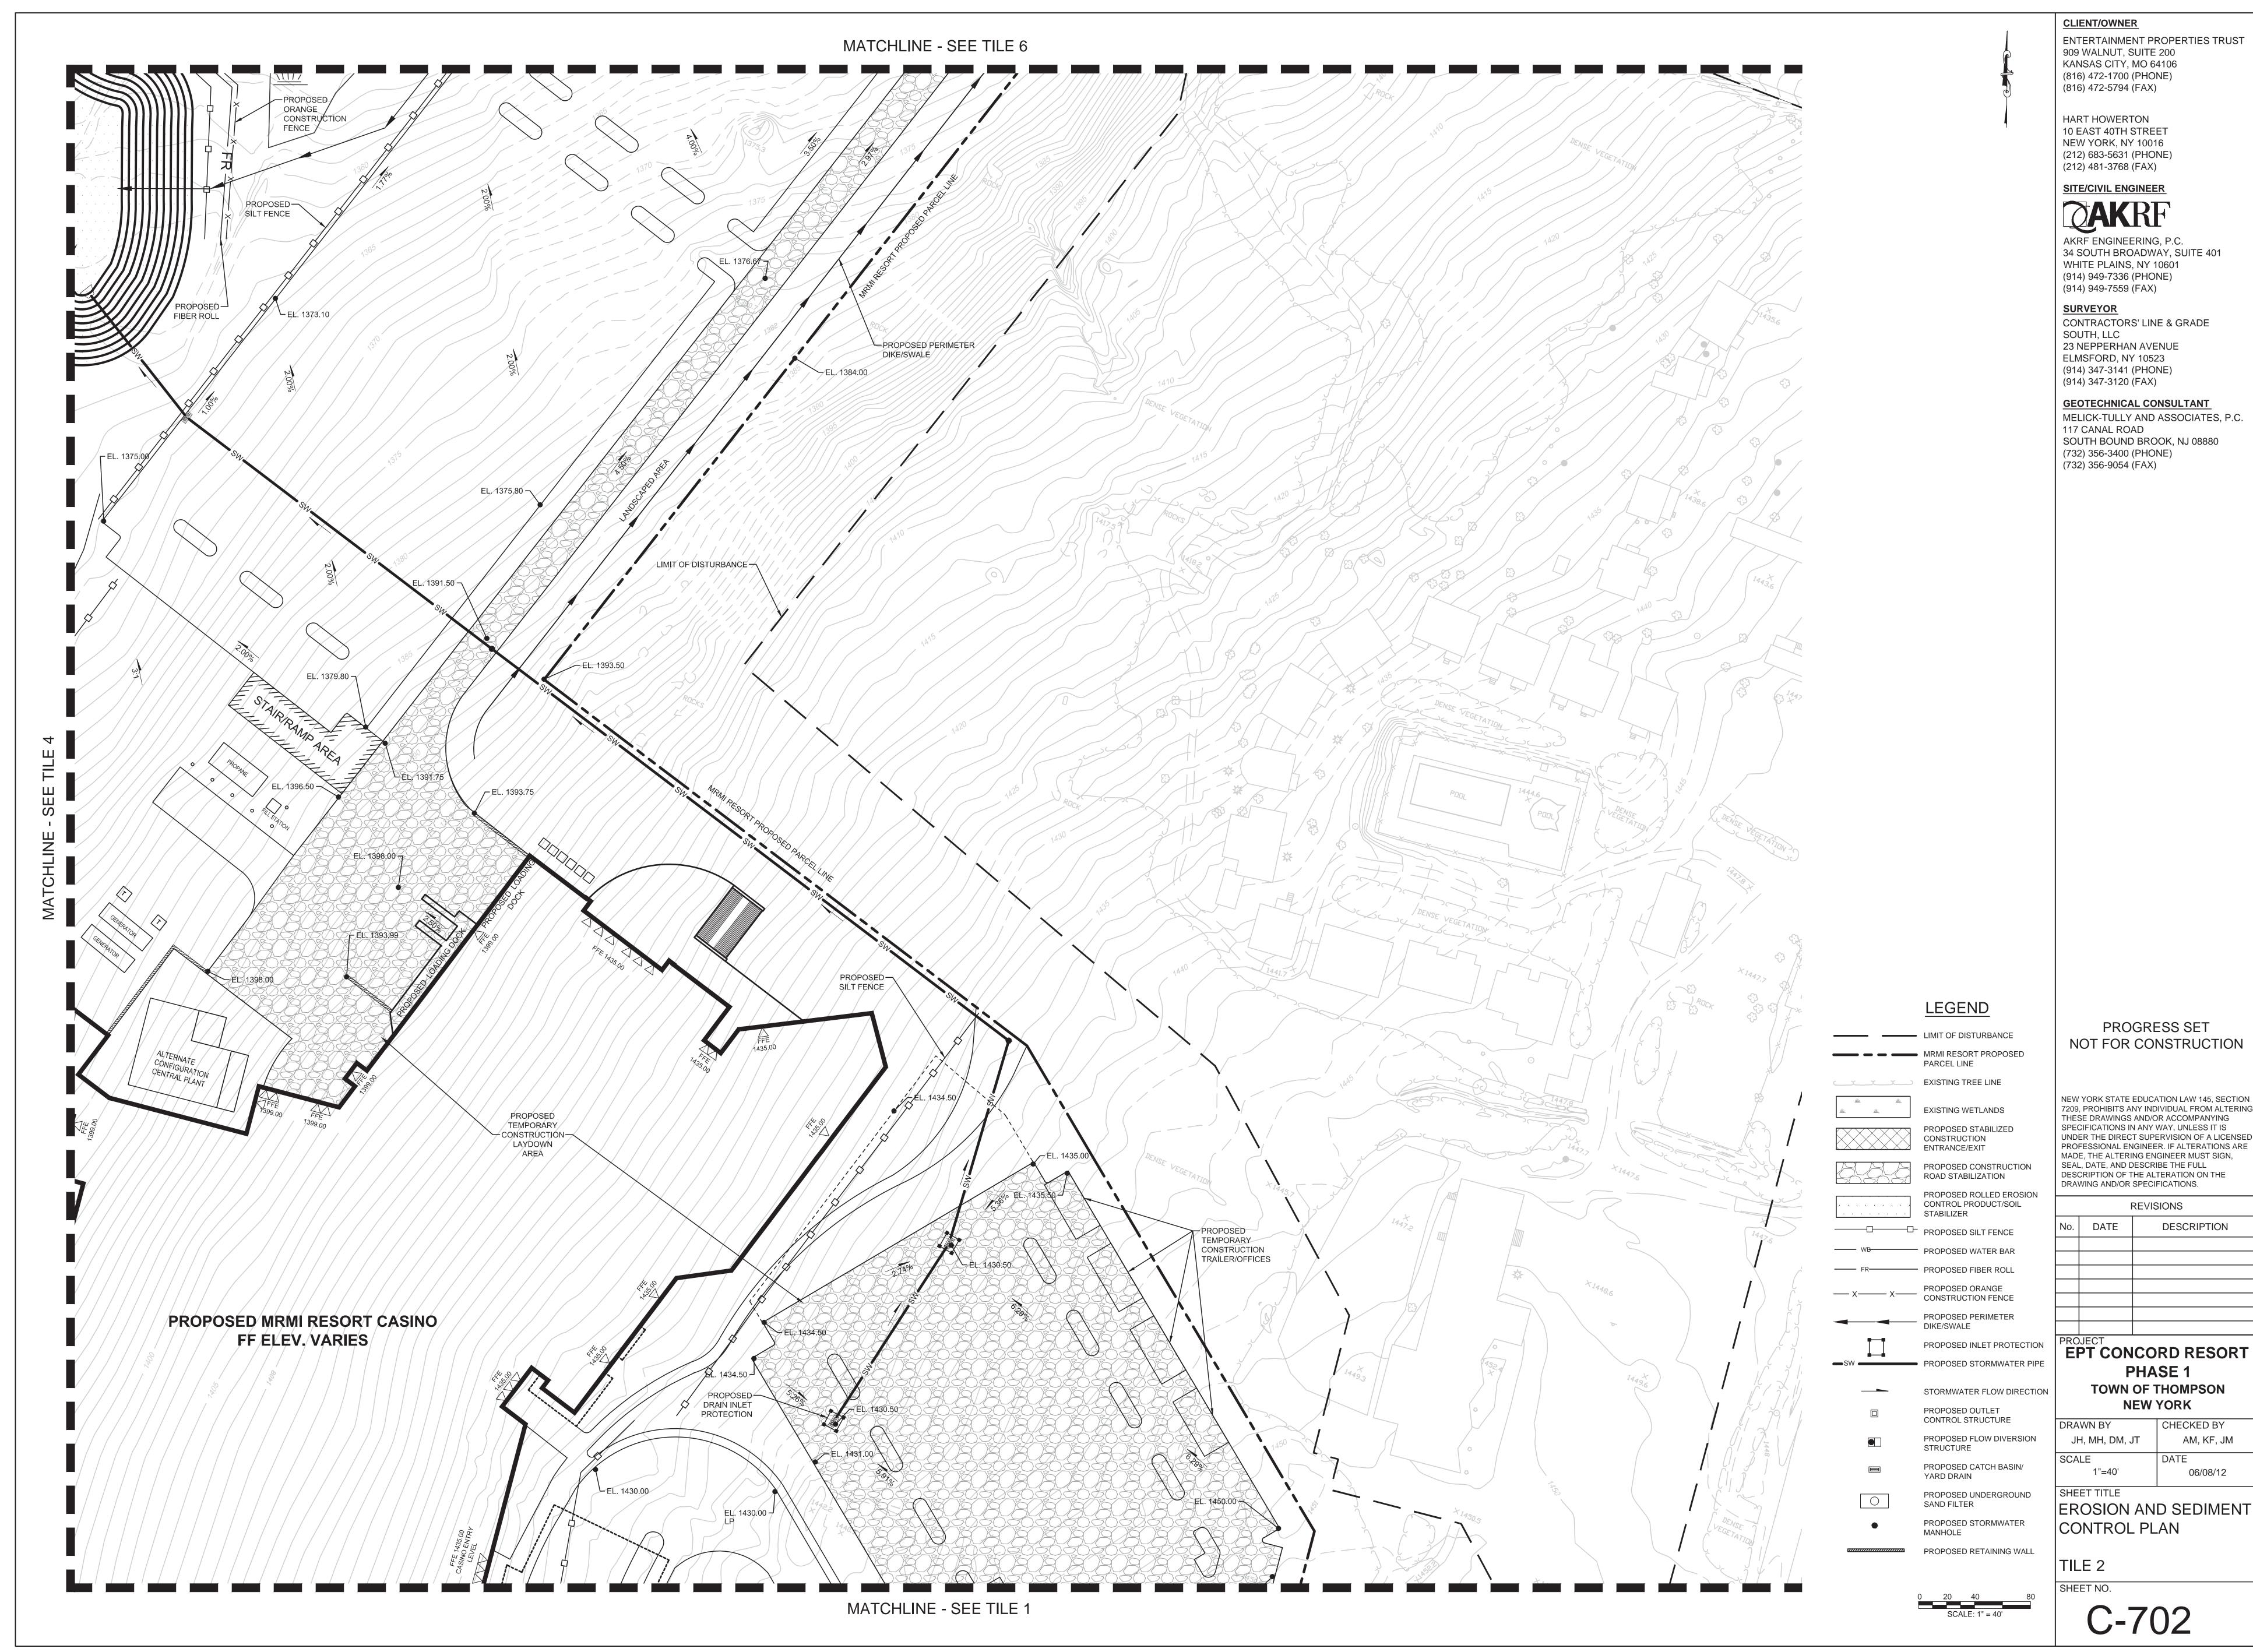

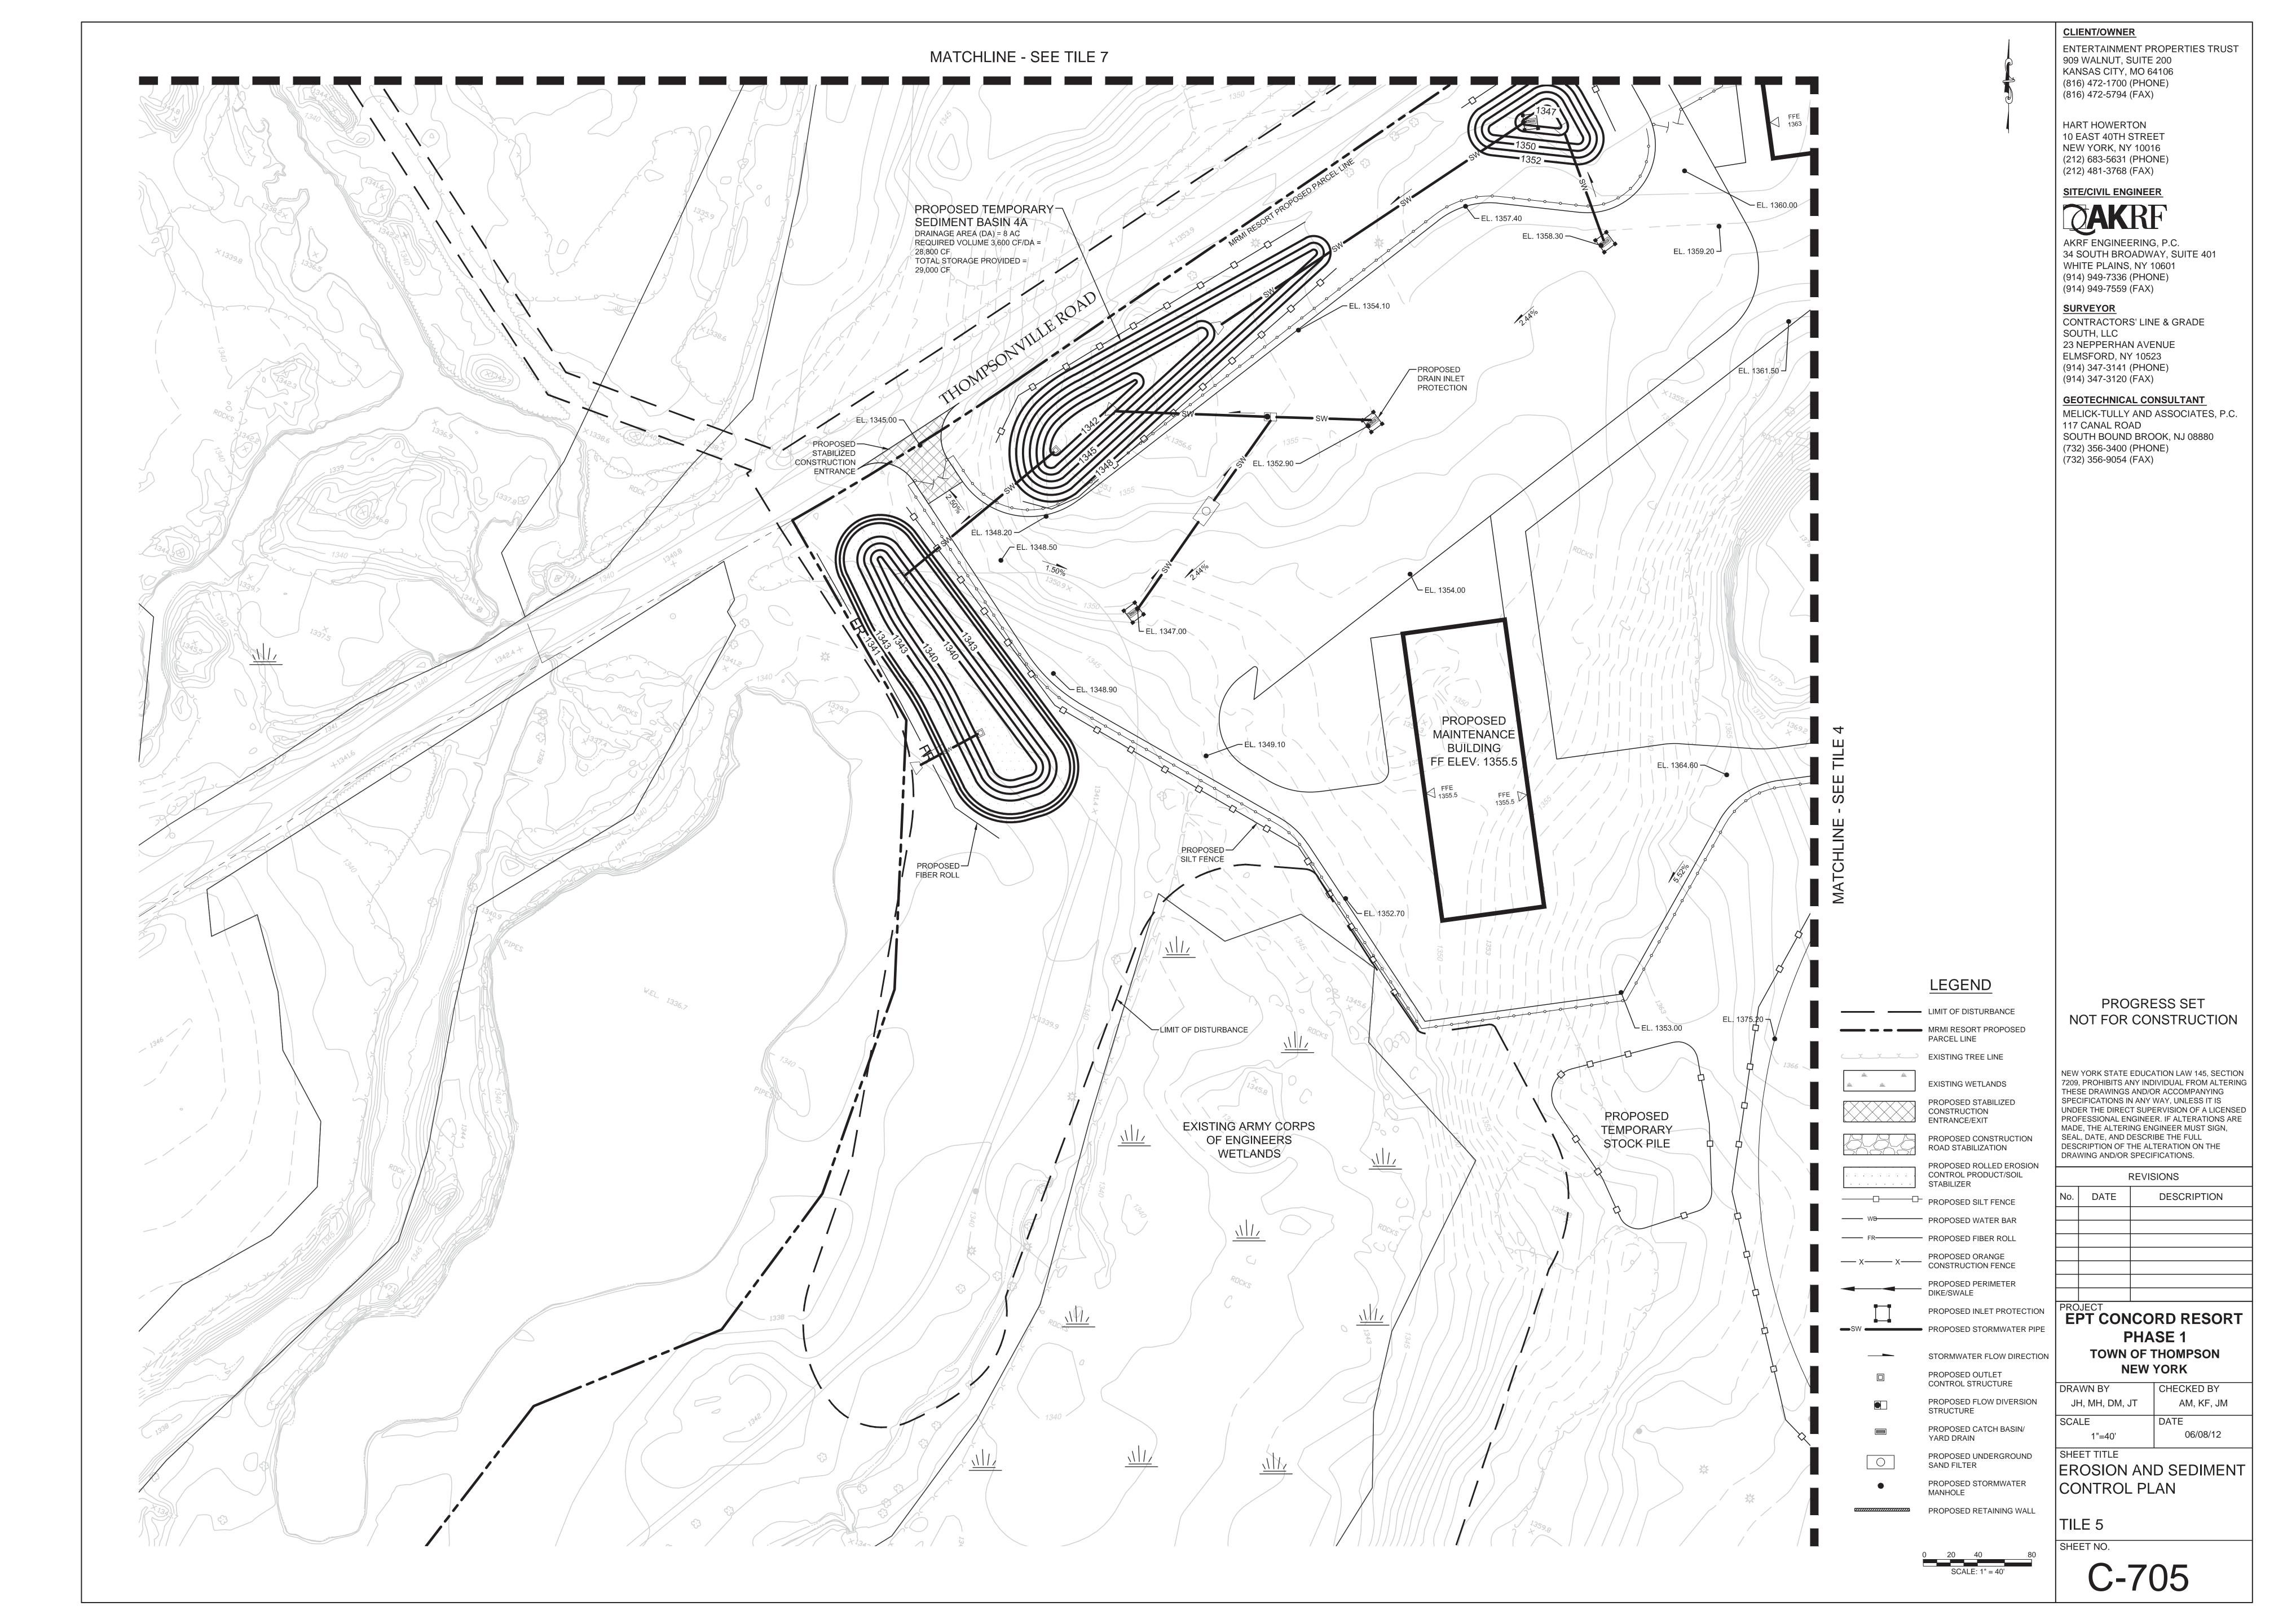

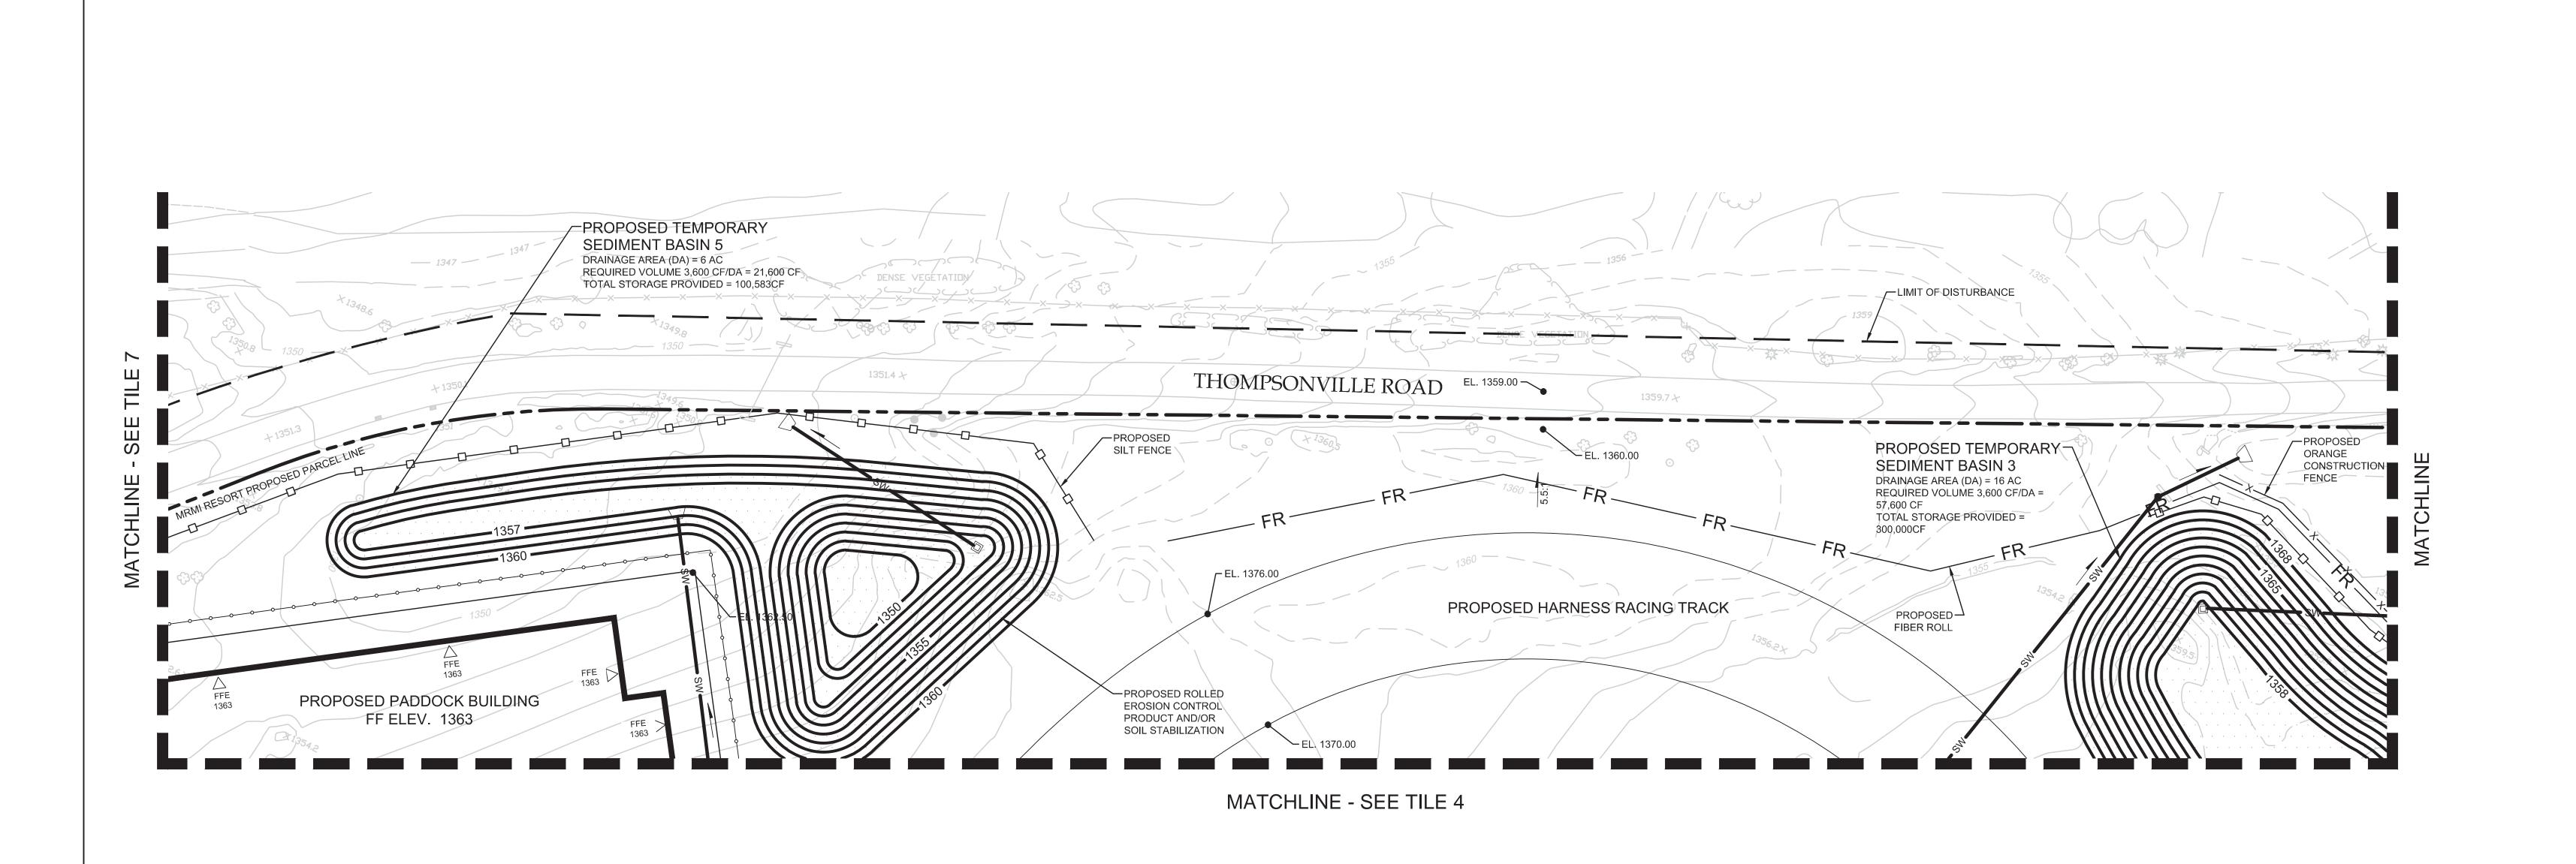

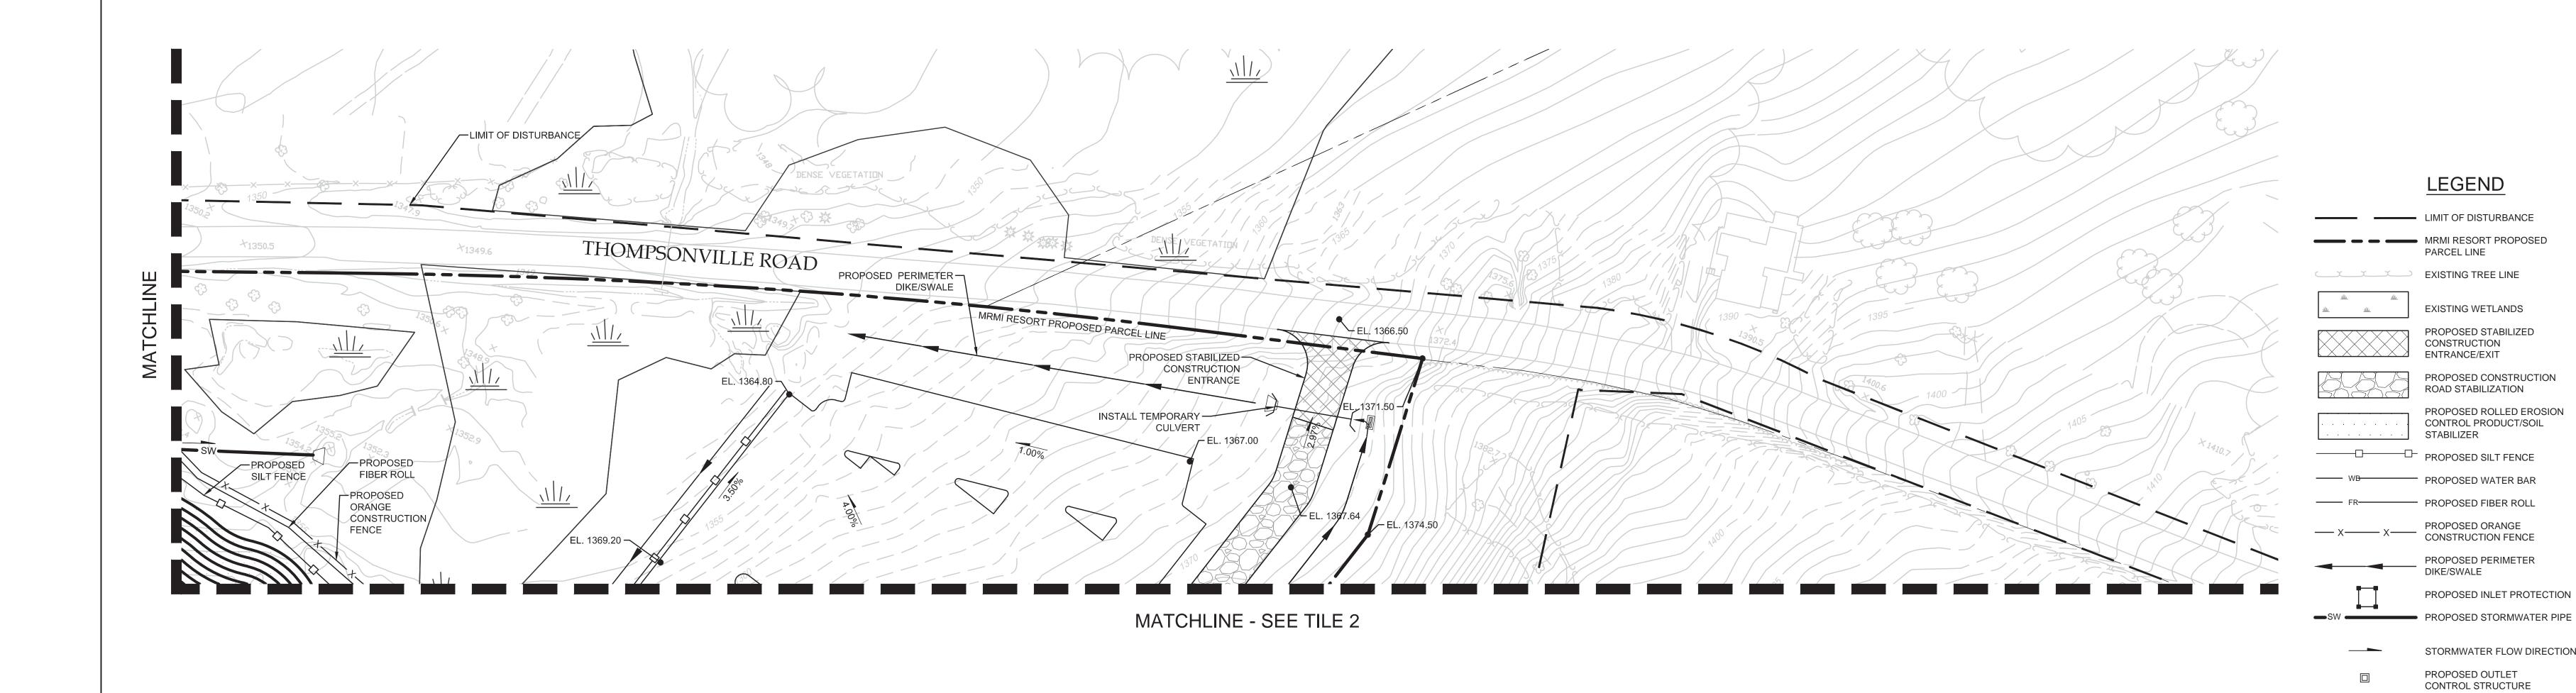

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DESCRIPTION

REVISIONS

EPT CONCORD RESORT PHASE 1 TOWN OF THOMPSON

NEW YORK DRAWN BY CHECKED BY PROPOSED FLOW DIVERSION AM, KF, JM SCALE 06/08/12 1"=40'

SHEET TITLE PROPOSED UNDERGROUND SAND FILTER PROPOSED STORMWATER

STRUCTURE

YARD DRAIN

MANHOLE


PROPOSED CATCH BASIN/

PROPOSED RETAINING WALL

EROSION AND SEDIMENT CONTROL PLAN


> TILE 6 SHEET NO.



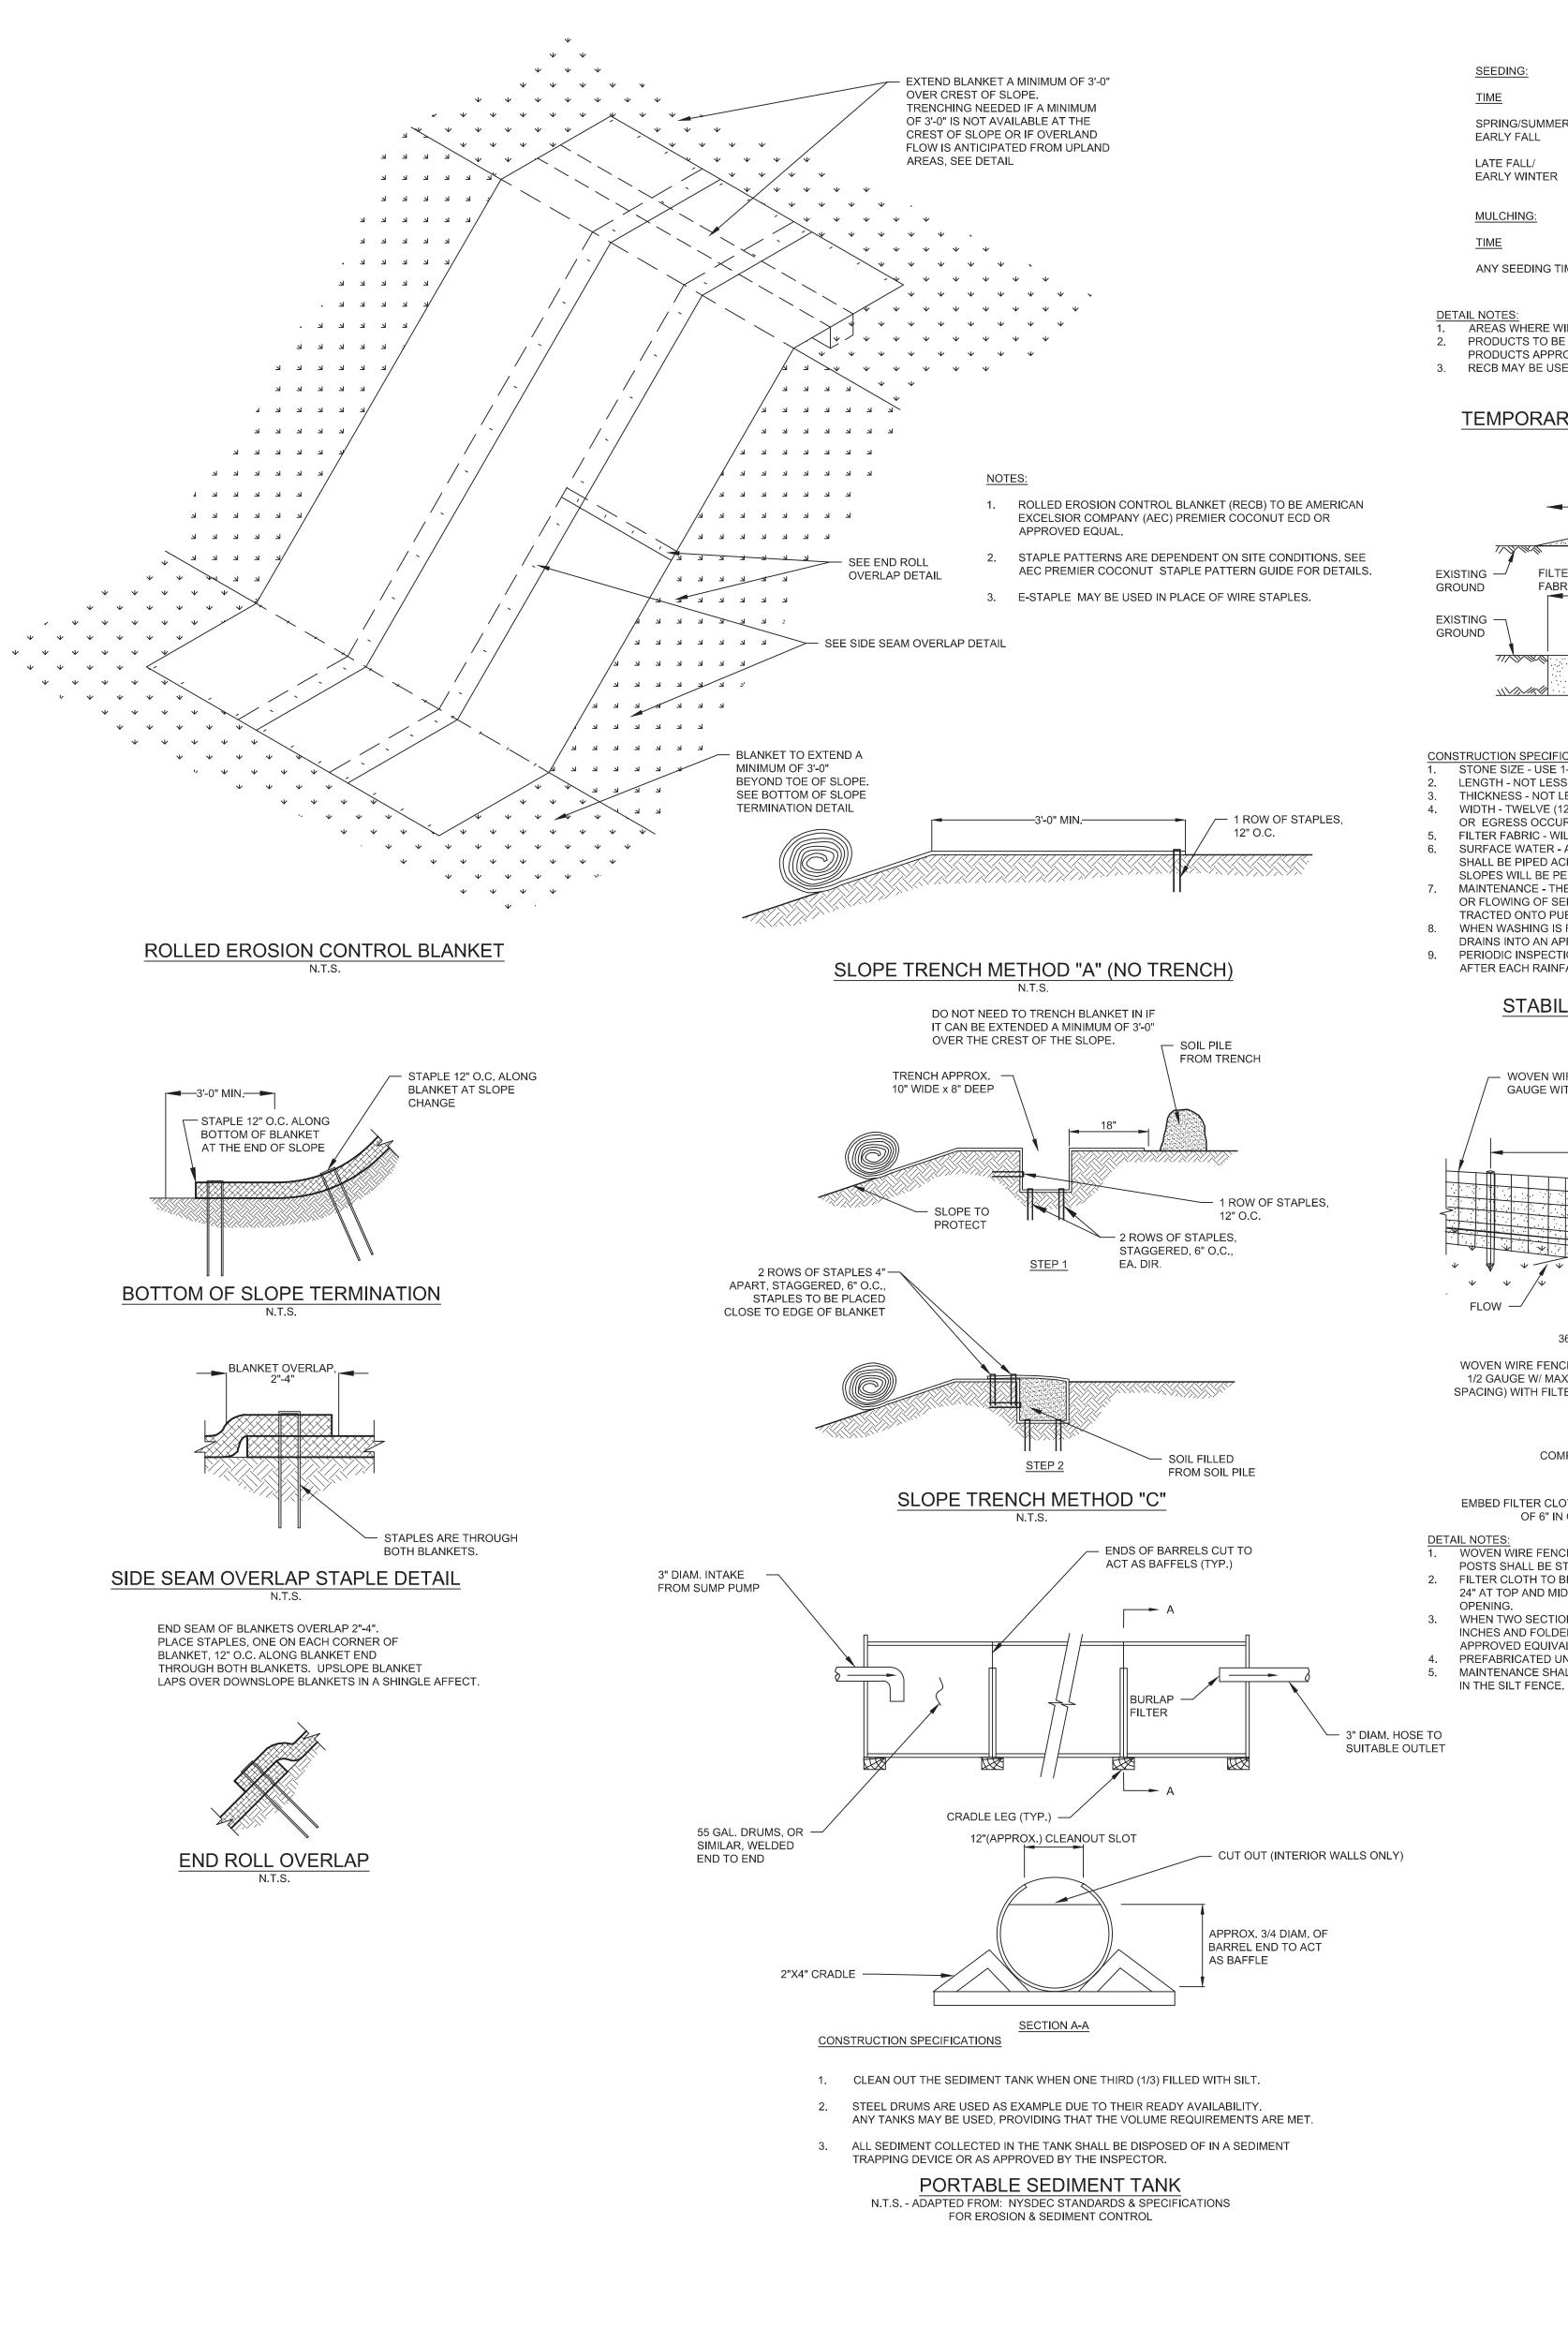

SPRING/SUMMER/ RYEGRASS (ANNUAL OR 30 LBS. PER ACRE (1 LB./1000 SF) EARLY FALL PERENNIAL) LATE FALL/ CERTIFIED 'AROOSTOOK' 100 LBS. PER ACRE (2.5 LBS. /1000 S.F.) EARLY WINTER (CEREAL RYE) MULCHING: 2 TONS PER ACRE (90 LBS. PER 1000 S.F.) ANY SEEDING TIME HAY OR STRAW AREAS WHERE WIND AND CONCENTRATED WATER ARE CONCERNS WILL REQUIRE MULCH ANCHORING PRODUCTS TO BE USED FOR MULCH ANCHORING ARE WOOD FIBER HYDROMULCH OR OTHER SPRAYABLE PRODUCTS APPROVED FOR EROSION CONTROL 3. RECB MAY BE USED IN LIEU OF MULCHING

TEMPORARY SEEDING AND MULCHING SCHEDULE

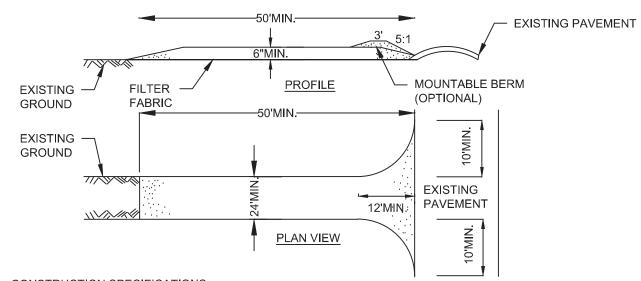


STONE SIZE - USE 1-4 INCHES STONE, OR RECLAIMED OR RECYCLED CONCRETE EQUIVALENT. LENGTH - NOT LESS THAN 50 FEET

THICKNESS - NOT LESS THAN SIX (6) INCHES. WIDTH - TWELVE (12) FOOT MINIMUM, BUT NOT LESS THAN THE FULL WIDTH AT POINTS WHERE INGRESS OR EGRESS OCCURS, TWENTY-FOUR (24) FOOT IF SINGLE ENTRANCE TO SITE. FILTER FABRIC - WILL BE PLACED OVER THE ENTIRE AREA PRIOR TO PLACING OF STONE. SURFACE WATER - ALL SURFACE WATER FLOWING OR DIVERTED TOWARD CONSTRUCTION ENTRANCES SHALL BE PIPED ACROSS THE ENTRANCE. IF PIPING IS IMPRACTICAL, A MOUNTABLE BERM WITH 5:1 SLOPES WILL BE PERMITTED. MAINTENANCE - THE ENTRANCE SHALL BE MAINTAINED IN A CONDITION WHICH WILL PREVENT TRACKING

OR FLOWING OF SEDIMENT ONTO PUBLIC RIGHTS-OF-WAY, ALL SEDIMENT SPILLED, DROPPED, WASHED OR TRACTED ONTO PUBLIC RIGHTS-OF-WAY MUST BE REMOVED IMMEDIATELY. WHEN WASHING IS REQUIRED, IT SHALL BE DONE ON AN AREA STABILIZED WITH STONE AND WHICH DRAINS INTO AN APPROVED SEDIMENT TRAPPING DEVICE.


PERIODIC INSPECTION AND NEEDED MAINTENANCE SHALL BE PROVIDED EVERY 7 CALENDAR DAYS AND AFTER EACH RAINFALL EVENT.

STABILIZED CONSTRUCTION ENTRANCE/EXIT

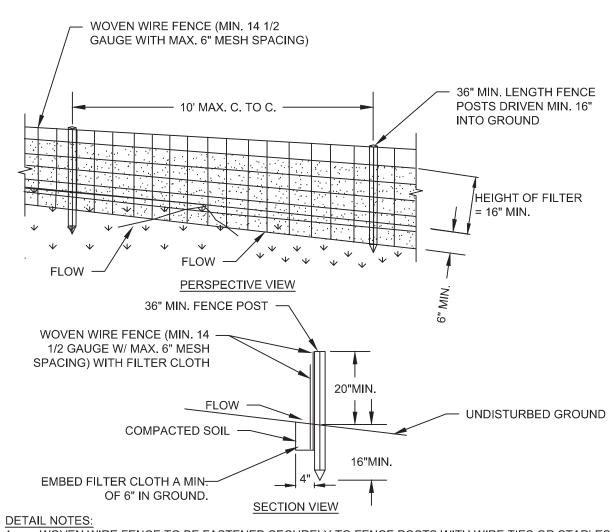

WOVEN WIRE FENCE TO BE FASTENED SECURELY TO FENCE POSTS WITH WIRE TIES OR STAPLES. POSTS SHALL BE STEEL EITHER "T" OR "U" TYPE OR HARDWOOD. FILTER CLOTH TO BE TO BE FASTENED SECURELY TO WOVEN WIRE FENCE WITH TIES SPACED EVERY 24" AT TOP AND MID SECTION. FENCE SHALL BE WOVEN WIRE, 6" MAXIMUM MESH

WHEN TWO SECTIONS OF FILTER CLOTH ADJOIN EACH OTHER THEY SHALL BE OVER-LAPPED BY SIX INCHES AND FOLDED. FILTER CLOTH SHALL BE EITHER FILTER X, MIRAFI 100X, STABILINKA T140N, OR PREFABRICATED UNITS SHALL BE GEOFAB, ENVIROFENCE, OR APPROVED EQUIVALENT. MAINTENANCE SHALL BE PERFORMED AS NEEDED AND MATERIAL REMOVED WHEN "BULGES" DEVELOP

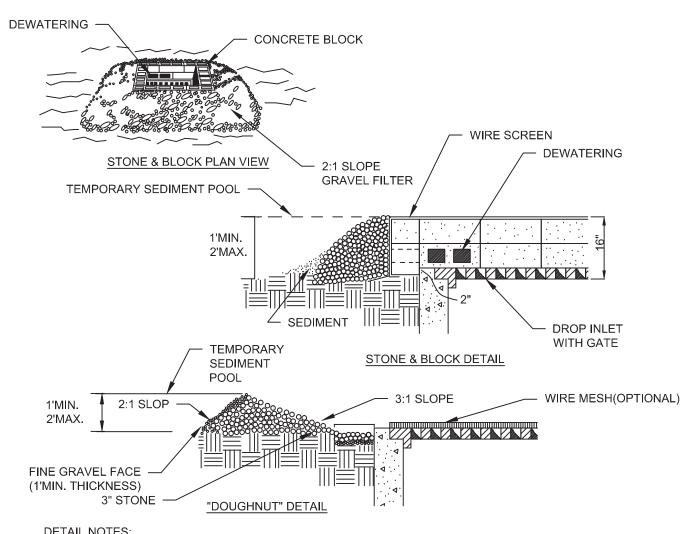

DETAIL NOTES:


1. THIS INLET PROTECTION STRUCTURE IS ONLY TO BE USED IN AREAS WHERE PAVEMENT HAS

2. LAY ONE BLOCK ON EACH SIDE OF THE STRUCTURE ON ITS SIDE FOR DEWATERING FOUNDATION SHALL BE 2 INCHES MINIMUM BELOW REST OF INLET AND BLOCKS SHALL BE PLACED AGAINST INLET FOR SUPPORT. 3. HARDWARE CLOTH OR 1/2" WIRE MESH SHALL BE PLACED OVER BLOCK OPENINGS TO

SUPPORT STONE. 4. USE CLEAN STONE OR GRAVEL 1/2-3/4 INCH IN DIAMETER PLACED 2 INCHES BELOW TOP OF THE BLOCK ON A 2:1 SLOPE OR FLATTER.


FOR STONE STRUCTURES ONLY, A 1 FOOT THICK LAYER OF THE FILTER STONE WILL BE PLACED AGAINST THE 3 INCH STONE AS SHOWN ON THE DRAWINGS. 6 MAXIMUM DRAINAGE AREA 1 ACRE

STONE AND BLOCK DROP INLET PROTECTION N.T.S. ADAPTED FROM: NYSDEC STANDARDS & SPECIFICATIONS FOR EROSION & SEDIMENT CONTROL

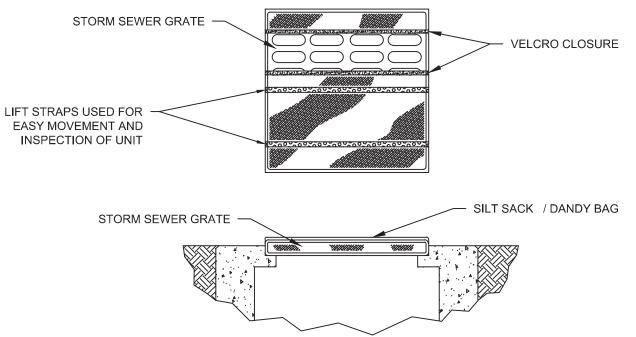

1. INLET SEDIMENT CONTROL DEVICE SHALL BE SILT SACK BY ACF ENVIRONMENTAL PRODUCTS DANDY BAG BY DANDY PRODUCTS, OR APPROVED EQUAL. 2. INLET SEDIMENT CONTROL DEVICE SHALL BE MAINTAINED AS PER THE STANDARDS AND SPECIFICATIONS OF THE NYSDEC STANDARDS FOR EROSION AND SEDIMENT CONTROL (BLUE BOOK). 3. ONCE THE CONTRIBUTING DRAINAGE AREA HAS BEEN COMPLETELY STABILIZED (GREATER THAN 75% VEGETATIVE COVER) THE INLET SEDIMENT CONTROL DEVICE SHALL BE CLEANED OUT AND REMOVED FROM THE STRUCTURE.

SILT SACK INLET PROTECTION

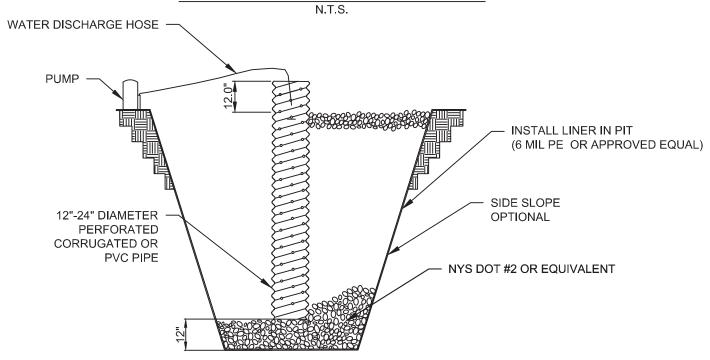


SUMP PIT TO BE USED IN COORDINATION WITH ANTI-TRACKING/DECONTAMINATION PAD. PIT DIMENSIONS ARE OPTIONAL 2. THE STANDPIPE SHOULD BE CONSTRUCTED BY PERFORATING A 12-24" DIAMETER CORRUGATED

A BASE OF 2" AGGREGATE SHOULD BE PLACED IN THE PIT TO A DEPTH OF 12". AFTER INSTALLING THE STANDPIPE, THE PIT SURROUNDING THE STANDPIPE SHOULD BE BACKFILLED

4. THE STANDPIPE SHOULD EXTEND 12-18" ABOVE THE LIP OF THE PIT.

5. WATER TO BE PLACED IN DOT APPROVED CONATINER FOR OFF SITE DISPOSAL

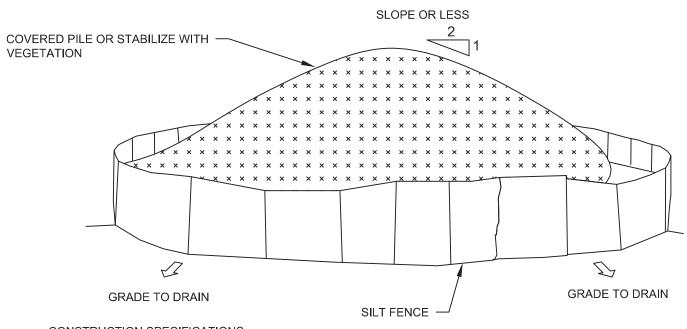

THIS DETAIL IS TO BE USED ONLY FOR CLEAN, TESTED MATERIAL STOCKPILING. 2. AREA CHOSEN FOR SOIL STOCKPILE SHALL BE DRY AND STABLE

3. MAXIMUM SLOPE OF SOIL STOCKPILE SHALL BE 2:1 4. PRIOR TO DISTURBING FILL MATERIAL, EACH PILE SHALL BE SURROUNDED BY SILT FENCING 5. UPON COMPLETION OF FILL MATERIAL GRADING, EACH PILE SHALL BE COVERED OR STABILIZED WITH

6. SEGREGATE CERTIFIED CLEAN MATERIALS FROM OTHER MATERIALS WHEN STOCKPILING.

SOIL STOCKPILE DETAIL

CLIENT/OWNER

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	I	REVISIONS
No.	DATE	DESCRIPTION

EPT CONCORD RESORT TOWN OF THOMPSON


NEW YORK DRAWN BY CHECKED BY

JH, MH, DM, JT AM, KF, JM SCALE DATE 06/08/12

SHEET TITLE

SHEET NO.

DETAILS I

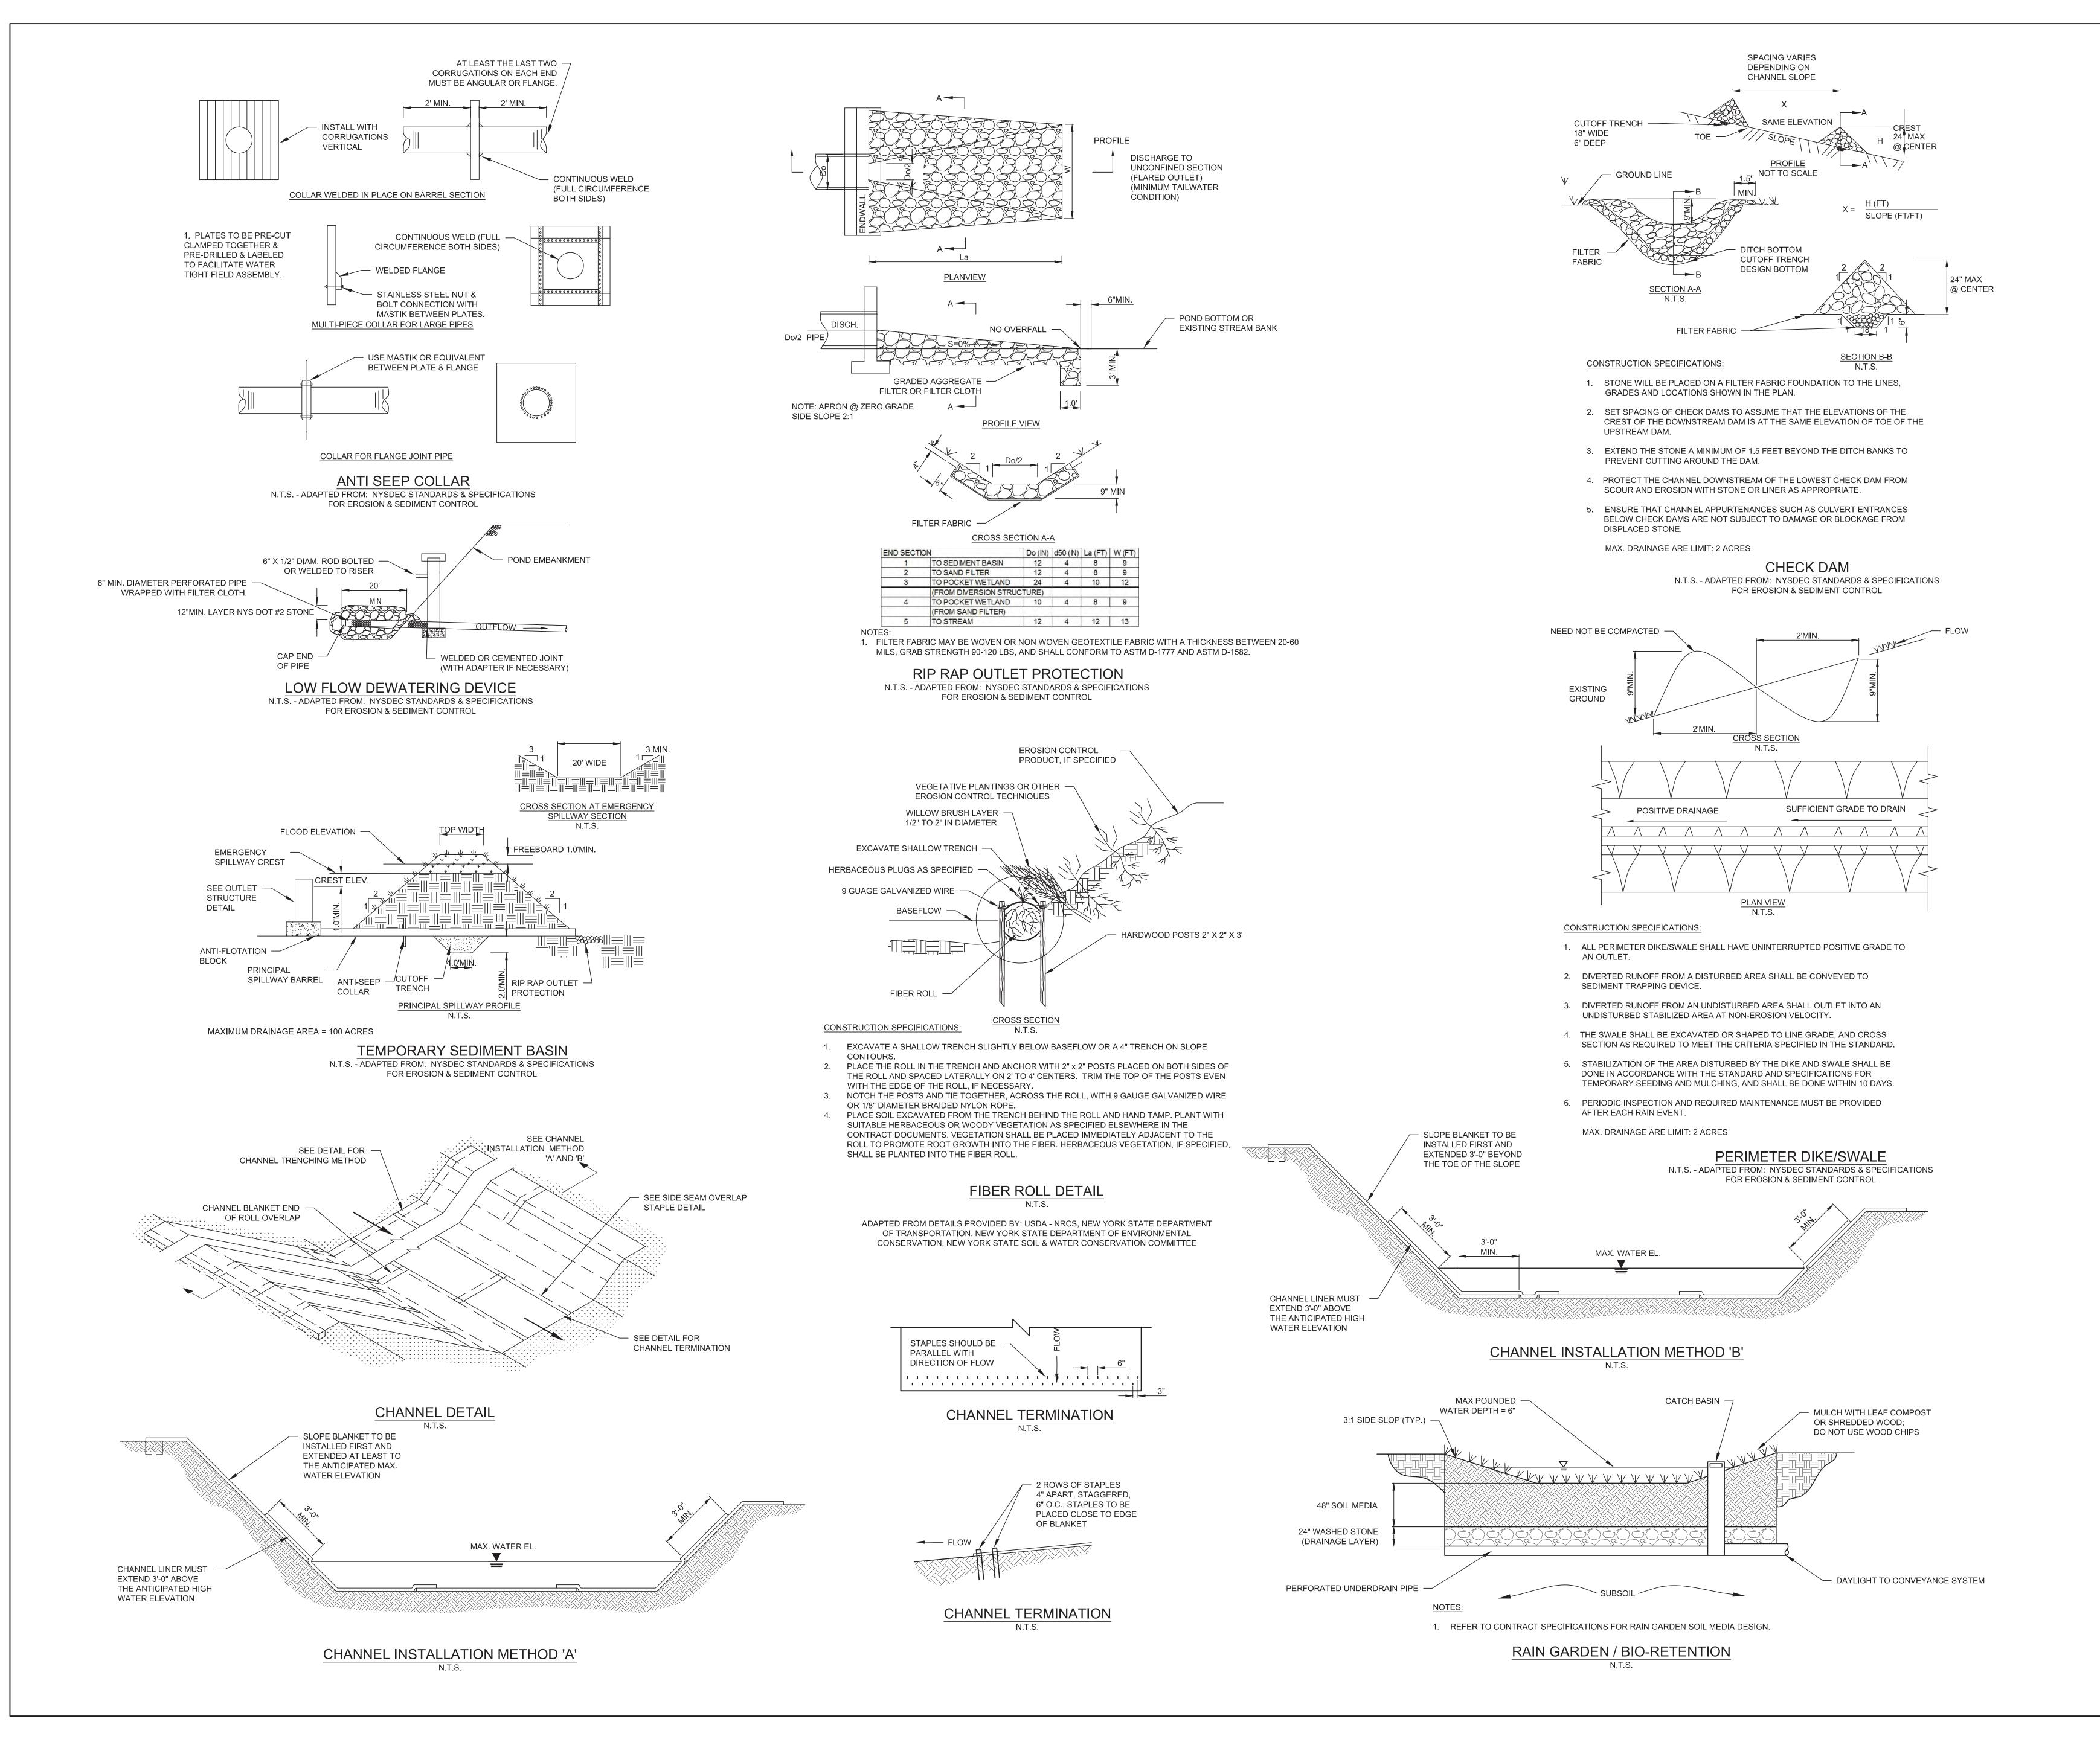

ENTERTAINMENT PROPERTIES TRUST 909 WALNUT, SUITE 200 KANSAS CITY, MO 64106 (816) 472-1700 (PHONE) (816) 472-5794 (FAX)

HART HOWERTON 10 EAST 40TH STREET NEW YORK, NY 10016 (212) 683-5631 (PHONE) (212) 481-3768 (FAX)

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WHITE PLAINS, NY 10601

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SURVEYOR

CONTRACTORS' LINE & GRADE
SOUTH, LLC

ELMSFORD, NY 10523 (914) 347-3141 (PHONE) (914) 347-3120 (FAX)

23 NEPPERHAN AVENUE

GEOTECHNICAL CONSULTANT

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PHASE 1
TOWN OF THOMPSON
NEW YORK

NEW YORK

DRAWN BY
JH, MH, DM, JT


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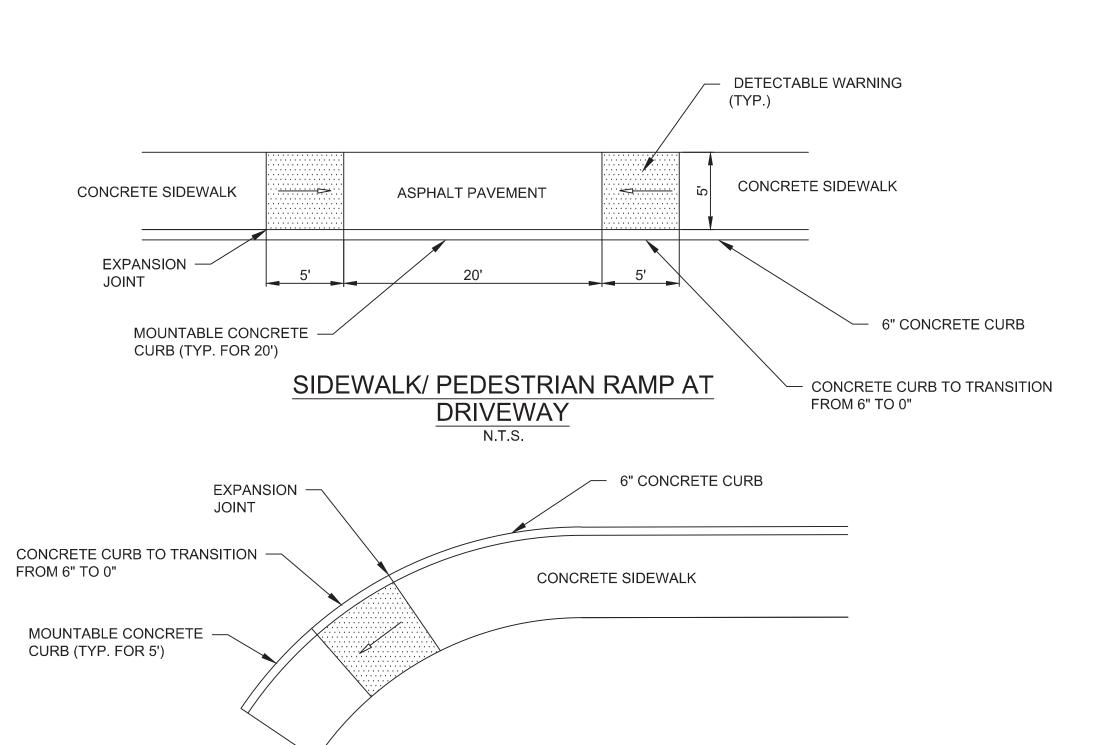
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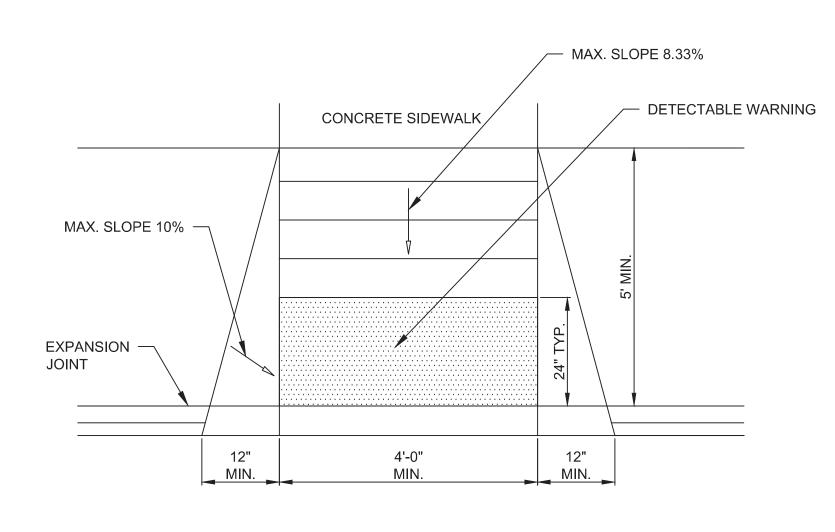
SHEET TITLE

DETAILS II




1. CONTRACTOR TO CONSTRUCT SIDEWALK IN ACCORDANCE WITH THE CONCRETE JOINT DETAIL.




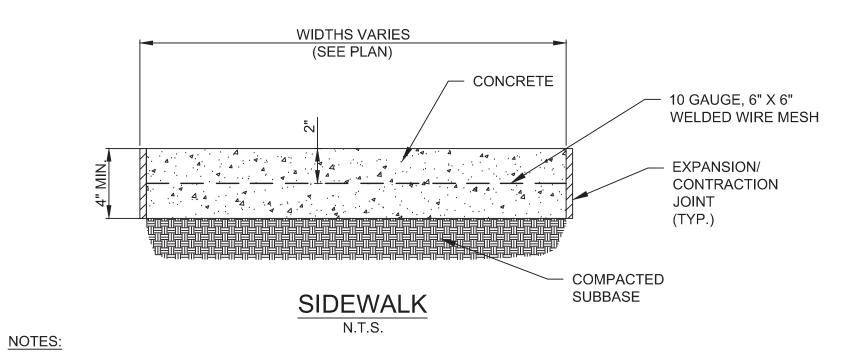

SIDEWALK/ PEDESTRIAN RAMPS

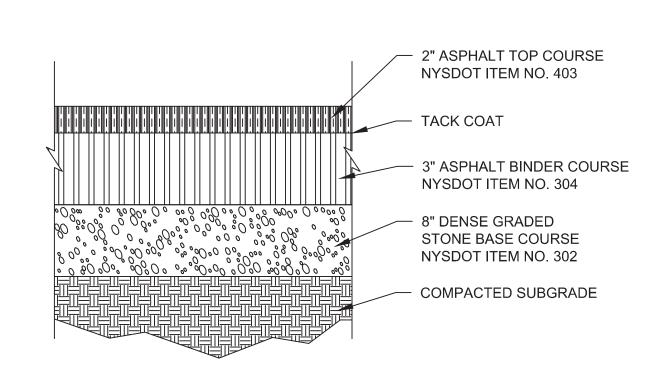


TYPICAL ASPHALT PAVEMENT SECTION (LIGHT DUTY)

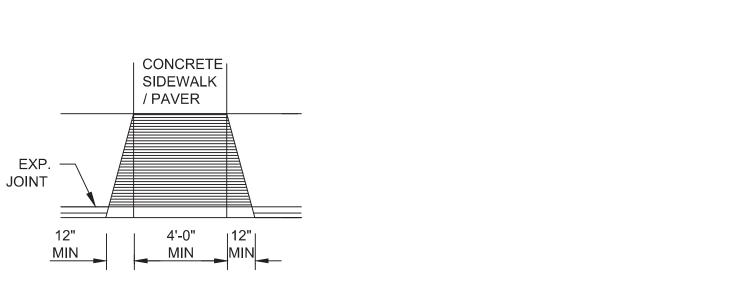


SIDEWALK/ PEDESTRIAN RAMPS

SIDEWALK/ PEDESTRIAN RAMP AT

SITE ENTRANCE

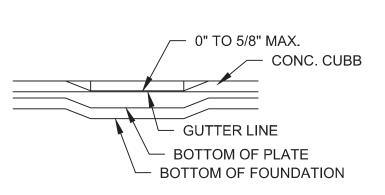


SIDEWALK/ PEDESTRIAN RAMP ELEVATION

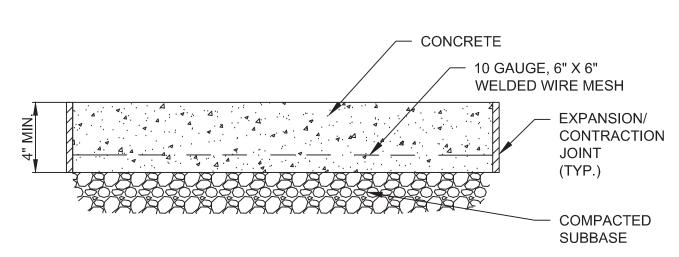


CONCRETE RAMP / PAD DETAIL

EXPANSION/CONTRACTION JOINT NOTES:

- 1. EXPANSION JOINTS SHALL BE PROVIDED AT EQUAL DISTANCES OF NO MORE THAN 20 FEET. ALL EXISTING AND PROPOSED BUILDINGS, CURBING AND EXISTING PAVEMENT JOINTS SHALL BE FILLED WITH PREFORMED EXPANSION JOINT FILLER, 1/2" THICK. THE JOINT SHALL BE RECESSED 1/4" FROM THE TOP OF THE SLAB.
- 2. TOOLED CONTRACTION JOINTS SHALL BE PROVIDED AT EQUAL DISTANCES OF NO MORE THAN 5 FEET. JOINTS SHALL BE SPACED TO RESULT IN A NEAT AND ORDERLY ARRAY OF CONCRETE PAVERS.

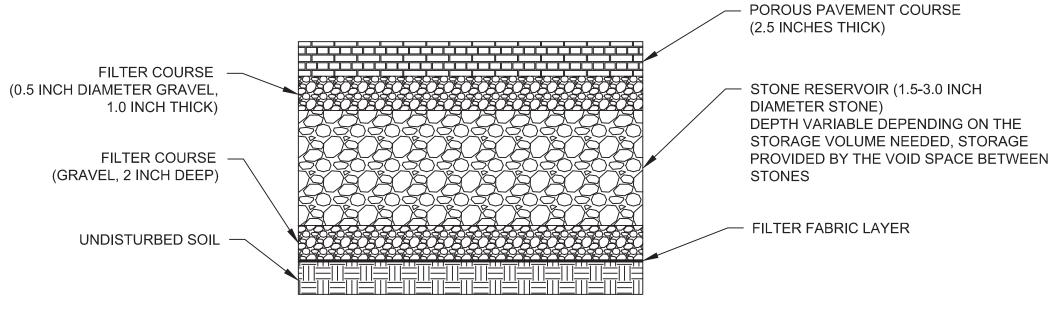


POROUS PAVEMENT DETAIL

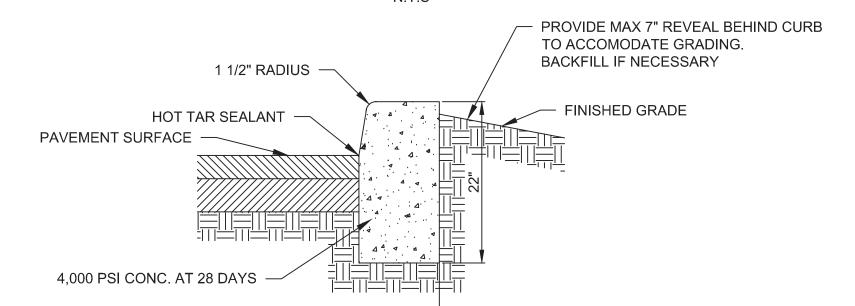


DETAIL NOTES:

- 1. ANY EXCAVATION BELOW DESIRED GRADE DUE TO OVER EXCAVATION OR WET SOIL CONDITIONS SHALL BE BACKFILLED WITH $\frac{3}{4}$ " CLEAN CRUSHED STONE. ALL SUBGRADES SHALL BE APPROVED BY THE ENGINEER PRIOR TO POURING.
- 2. EXPANSION JOINTS SHALL BE PROVIDED AT EQUAL DISTANCES OF NOT MORE THAN 20', ALL PC AND PT POINTS, AND ALL STORM SEWER INLETS. JOINTS SHALL BE FILLED WITH PREFORMED EXPANSION JOINT FILLER, $\frac{1}{2}$ " THICK. THE JOINT SHALL BE RECESSED $\frac{1}{4}$ " FROM THE TOP AND THE FRONT OF THE CONCRETE CURB

6" CONCRETE CURB DETAIL

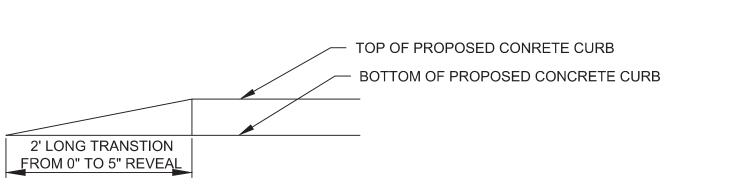


CONCRETE CURB TRANSITION DETAIL

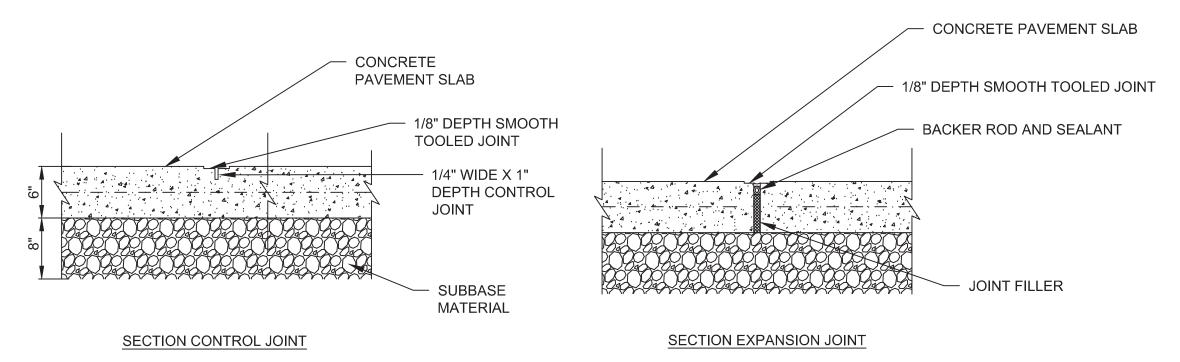

CONCRETE JOINT DETAIL

EXPANSION/CONTRACTION JOINT NOTES


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NOTES:

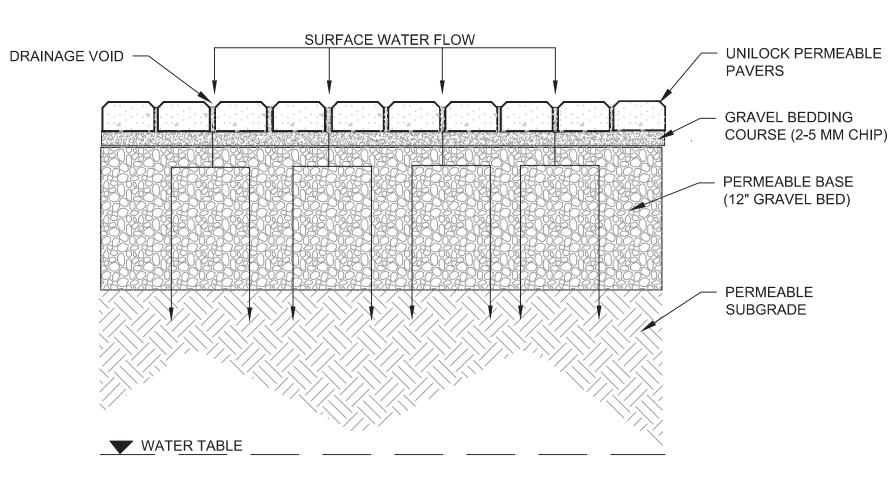1. REFER TO CONTRACT SPECIFICATIONS FOR PERMEABLE PAVER BASE COURSE DESIGN

PERMEABLE PAVERS



TYPICAL ASPHALT PAVEMENT SECTION (HEAVY DUTY)

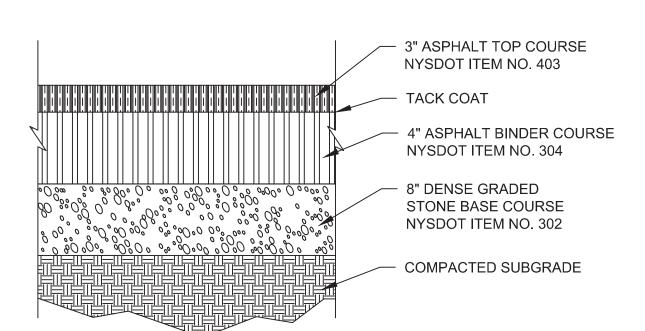PROGRESS SET

NOT FOR CONSTRUCTION

CLIENT/OWNER

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PHASE 1 TOWN OF THOMPSON

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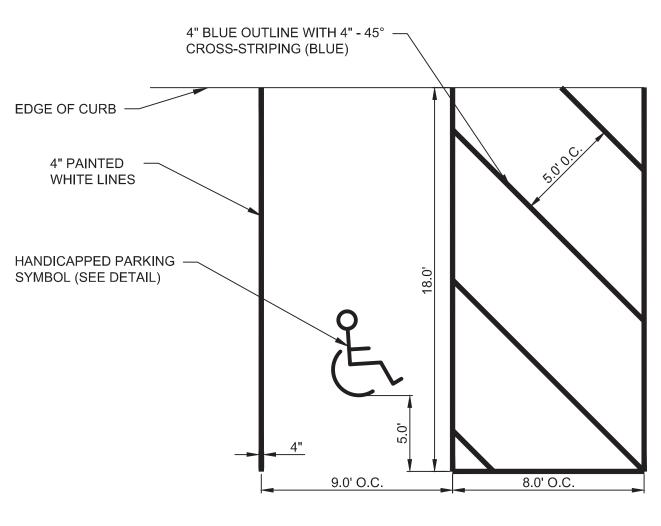
DATE

06/08/12


SHEET TITLE


DETAILS III


SHEET NO.



HANDICAP PARKING STALL PAVEMENT MARKINGS

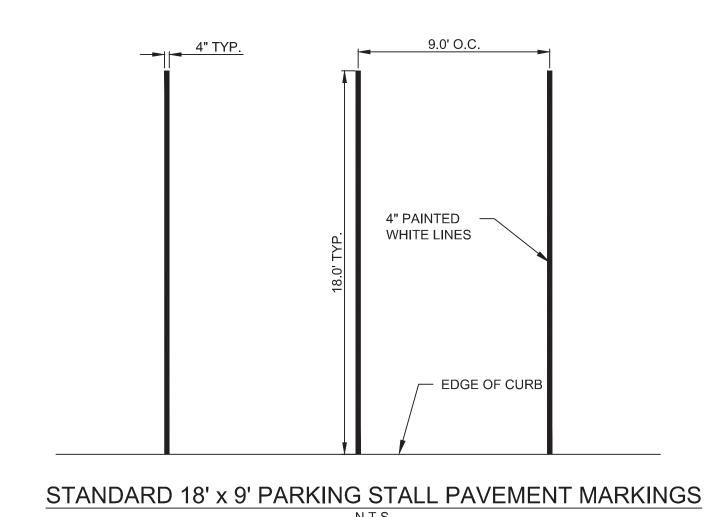

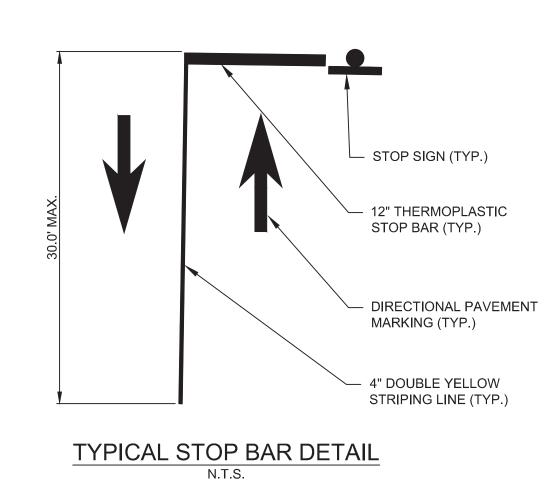

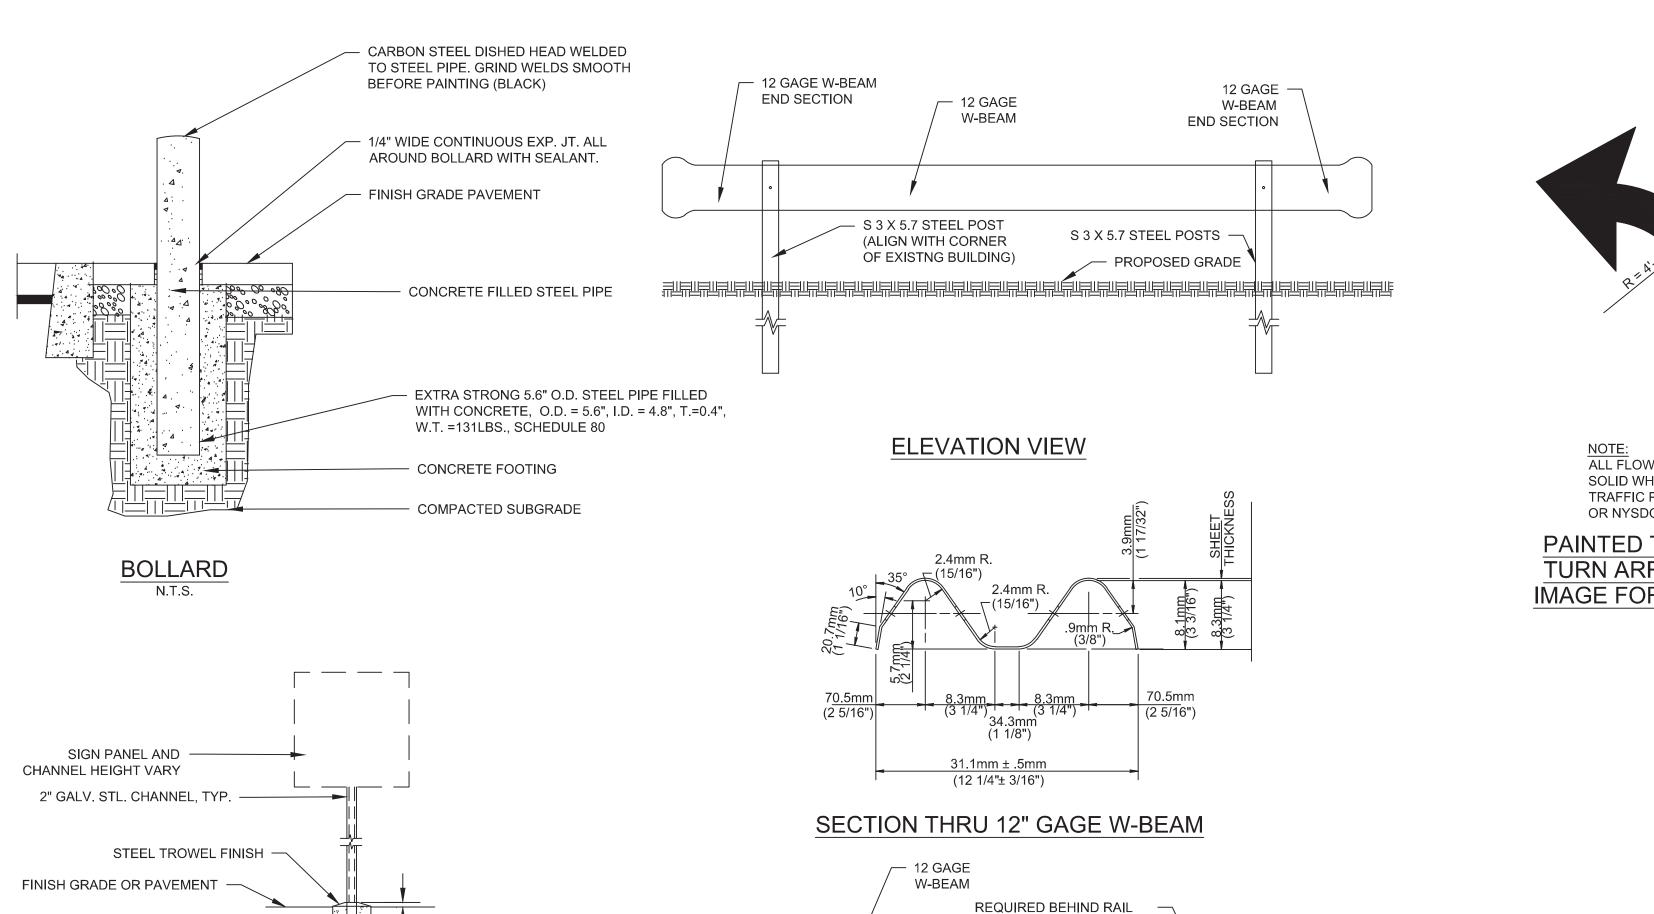

S 3 X 5.7 —

SIDE VIEW

STEEL POST


SOIL PLATE TYPICAL —

AT EACH NON-SPLICE IN

STEEL "H" BEAM POST &

BLOCK SYSTEM

OFFSET BLOCK SYSTEM & STEEL "C" POST & OFFSET

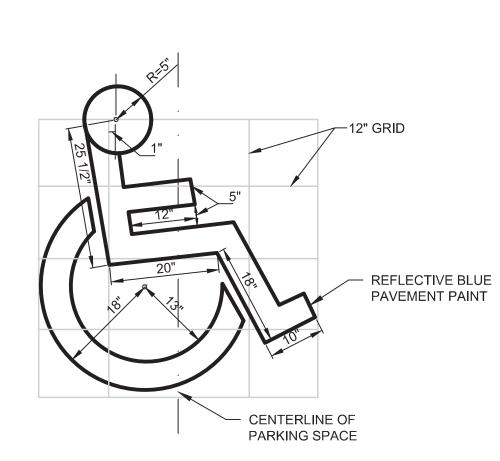

1. BOTTOM OF FOOTING TO BE 1'-0" BELOW FROST LINE,

EXISTING UNDISTURBED GRADE, OR COMPACTED FINISHED GRADE,


SIGNPOST DETAIL



8" DIA. MIN. CONC. FOOTING —

WHICHEVER IS GREATER.

NOTES:

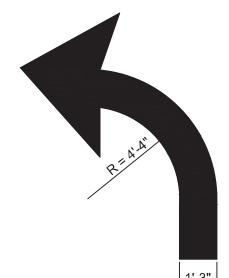

NOTE: ALL FLOW ARROWS TO BE SOLID WHITE REFLECTIVE TRAFFIC PAINT AS PER ABOVE OR NYSDOT STANDARD

PAINTED TRAFFIC LEFT **TURN ARROW (MIRROR** IMAGE FOR RIGHT TURN)

STANDARD W-BEAM

STANDARD 1.9MM X 6.4MM

(3/4" X 2 1/2")

BACK-UP PLATE

POST BOLT SLOP

RAIL MATERIAL



NOTE:
ALL FLOW ARROWS TO BE
SOLID WHITE REFLECTIVE OR NYSDOT STANDARD ARROW

TRAFFIC PAINT AS PER ABOVE PAINTED TRAFFIC

— 12" (W) X 18" (H) RESERVED PARKING - WHITE BACKGROUND GREEN LETTERS -

— 12" WIDE WHITE THERMOPLASTIC

CROSSWALK DETAIL

PAVEMENT MARKING

1. FABRICATE ALL SIGN PANELS OF 16 GA. ALUM. 2. POST MOUNT: USE NON-CORROSIVE .9mm (3/8") MACHINE BOLTS W/ WASHERS, 2 PER SIGN.

3. SIGN SHALL BE POST MOUNTED IN FRONT OF HANDICAP STALL. HANDICAP PARKING SIGN DETAIL

> PROGRESS SET NOT FOR CONSTRUCTION

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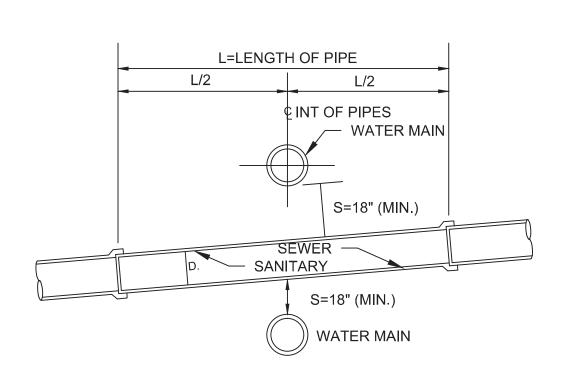
EPT CONCORD RESORT PHASE 1 **TOWN OF THOMPSON NEW YORK**

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SHEET TITLE

DETAILS IV


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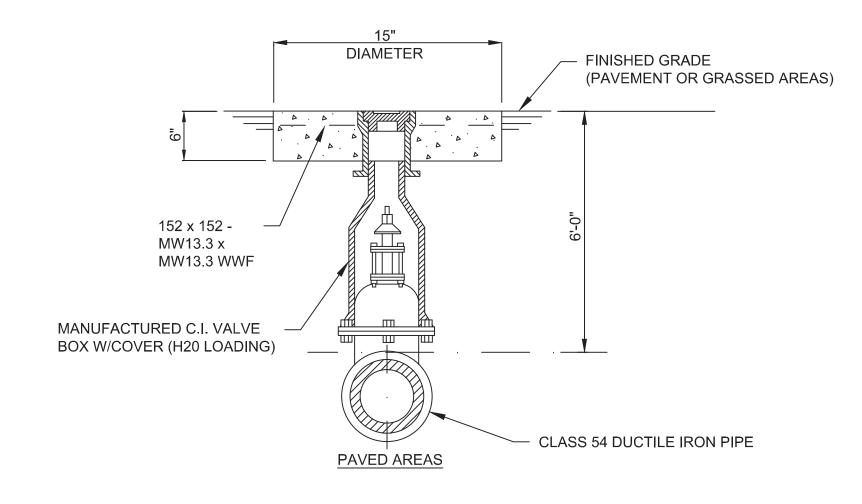
IF NON-PRESSURE CAST IRON, VITRIFIED TILE OR ASBESTOS CEMENT SEWER PIPE PASSES BENEATH A WATER MAIN WITH A VERTICAL SEPARATION (S) OF LESS THAN 18" INCHES, THEN THE SEWER LINE MUST BE INSTALLED AS FOLLOWS:

- A) THREE (3) LENGTHS OF EITHER CAST IRON OR ASBESTOS CEMENT PRESSURE PIPE MUST BE USED. THE MIDDLE LENGTH SHALL BE PLACE SO THAT THE JOINTS ARE EQUIDISTANT FROM THE WATER MAIN. (SEE DETAIL)
- THE THREE (3) LENGTHS OF PRESSURE PIPE MUST BE TESTED IN THE SAME MANNER AS REQUIRED FOR WATER MAINS. (SEE SPECIFICATION)
- IN THOSE CASES WHERE, DUE TO FIELD CONDITIONS, THE SEWER MUST BE PLACED ABOVE THE WATER MAIN, THEN THE REQUIREMENTS AS STATED IN (A) & (B) MUST BE ADHERED TO.
- EACH VARIATION OF WATER-SEWER CROSSINGS FROM THAT SHOWN ON THIS DETAIL SHALL BE INDIVIDUALLY REVIEWED AND APPROVED BY THE HEALTH DEPARTMENT.

DETAIL OF SANITARY SEWER - WATER MAIN CROSSING




DETAIL OF WATER SERVICE CONNECTION

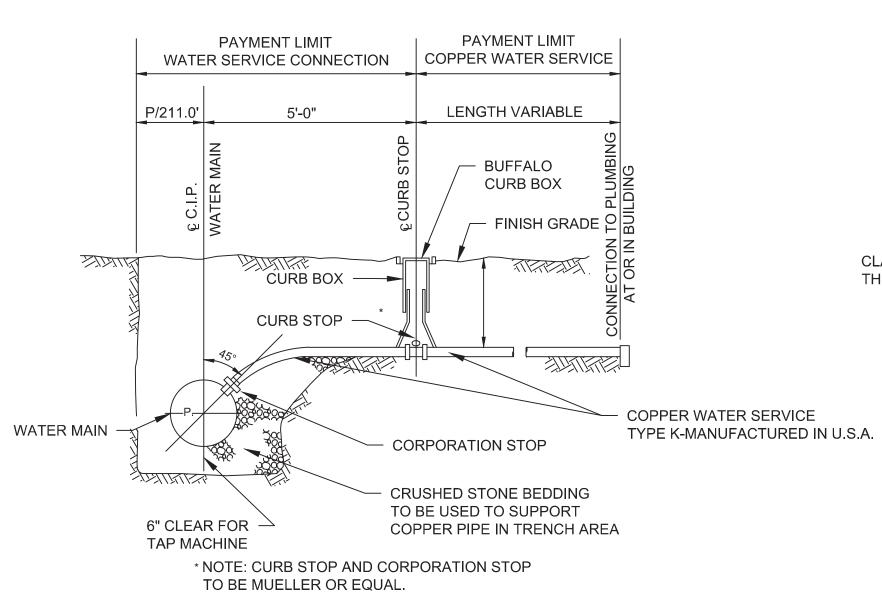


- 1. WORD "WATER" TO BE CAST INTO CENTER OF CAST IRON
- 2. VALVE BOX AND COVER SHALL BE CAMPBELL FOUNDARY MODEL NO. 4425 OR APPROVED EQUAL.

TYPICAL VALVE BOX DETAILS

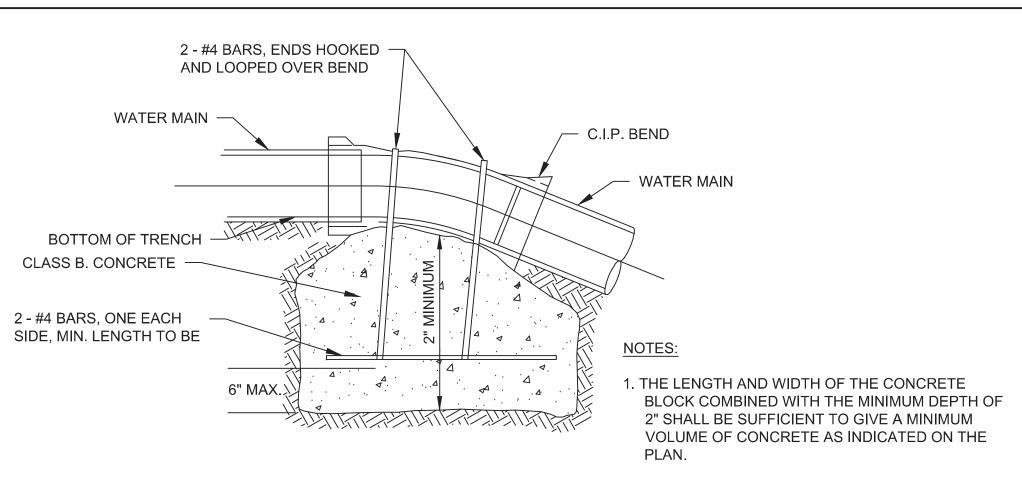


DETAIL OF CONCRETE ANCHOR

2-2 1/2" HOSE NOZZLE

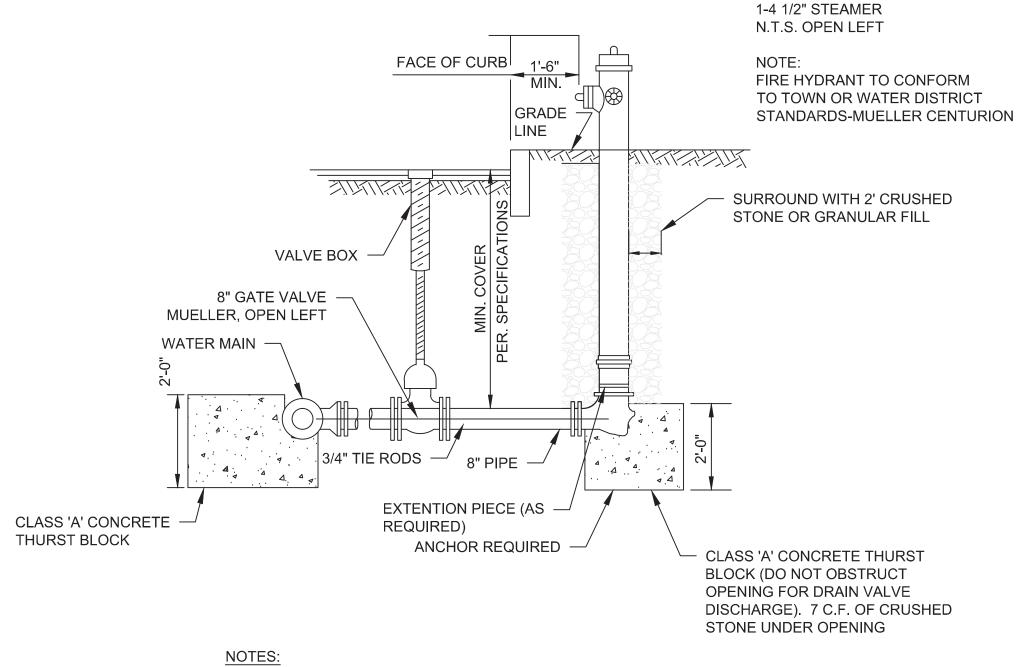


- 1. ALL CONCRETE BLOCKS TO BEAR UNDISTURBED GROUND. 2. 4 - 3/4" D BITUMINOUS COATED RODS WILL BE REQUIRED TIEING HYDRANT TO VALVE TO WATER MAIN.
- 3. WHERE THE WATER TABLE IS WHITHIN 7 FEET OF THE HYDRANT DRAINS SHOULD BE PLUGGED. WHEN THE DRAINS ARE PLUGGED THE BARRELS MUST BE PUMPED DRY AFTER USE DURING FREEZING WEATHER. WHERE HYDRANT DRAINS ARE NOT PLUGGED. A GRAVEL POCKET OR DRYWELL SHALL BE PROVIDED UNLESS THE NATURAL SOILS WILL PROVIDE ADEQUATE DRAINAGE HYDRANT DRAINS SHALL NOT BE CONNECTED TO BE LOCATED WITHIN 10 FEET OF SANITARY OR STORM DRAINS.
- 4. FIRE HYDRANT TO CONFORM TO TOWN OR WATER DISTRICT
- STANDARDS-MUELLER CENTURION. 5. 2 - 2 1/2" HOSE NOZZLE, 1 - 4 1/2" STEAMER


DETAIL OF TYPICAL HYDRANT

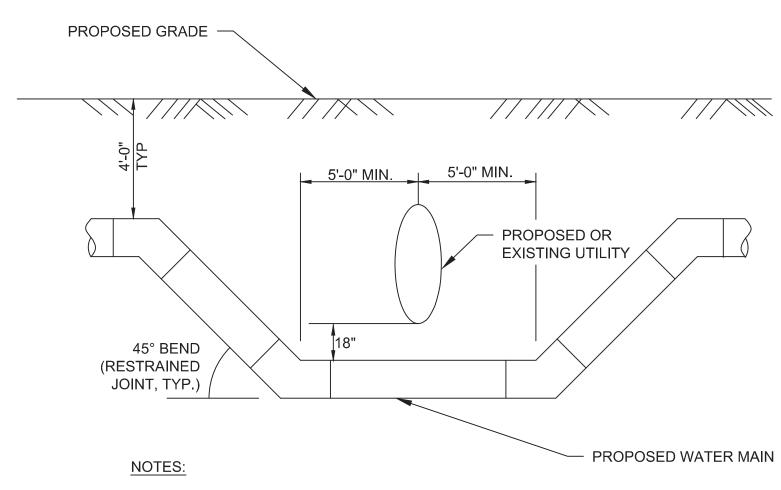


1. WHEN WATER MAIN CROSSES ELECTRICAL DUCT, THE 5' OFFSET SHALL BE FROM THE EDGE OF THE CONCRETE ENCASEMENT.

WATER MAIN CROSSING

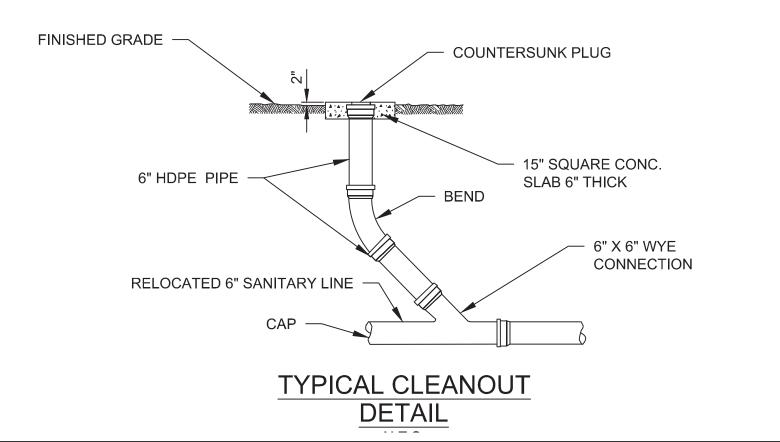


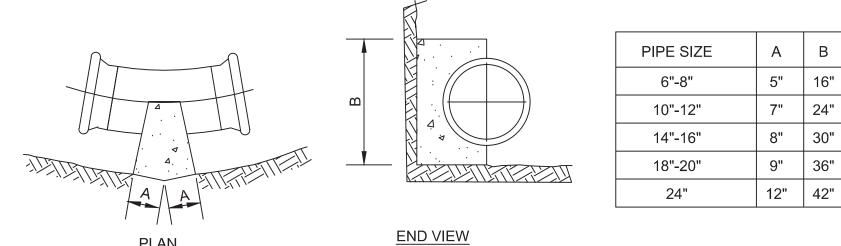


DETAIL OF 22 1/2° BEND ANCHOR

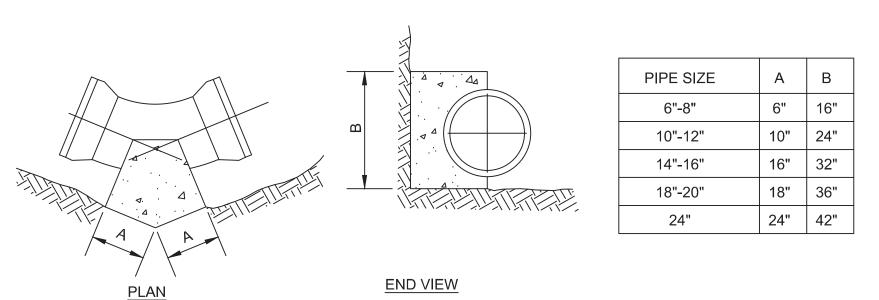


DETAIL OF 45° BEND ANCHOR

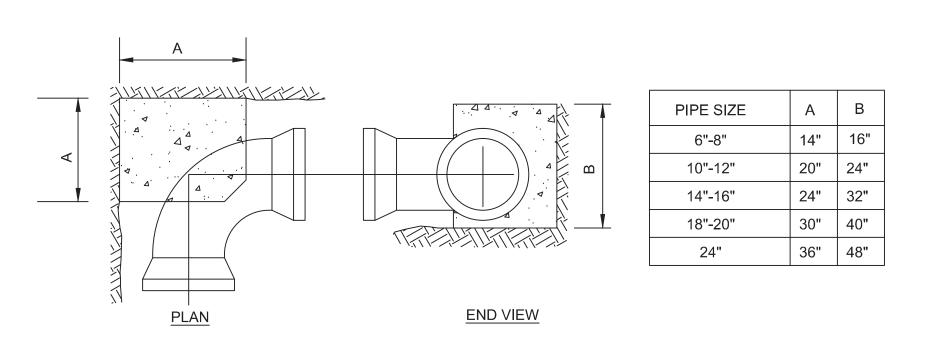

DETAIL OF 90° BEND ANCHOR

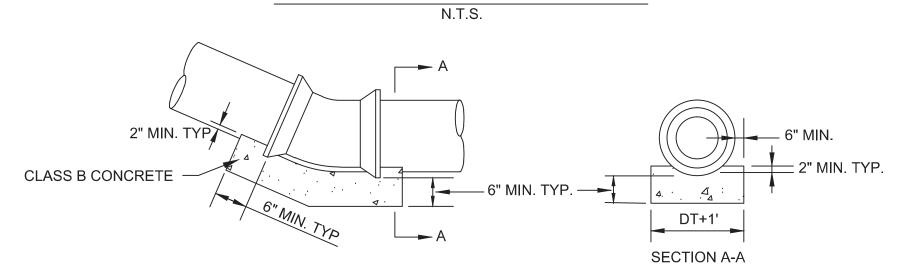

DETAIL OF THRUST DISTRIBUTION BLOCK

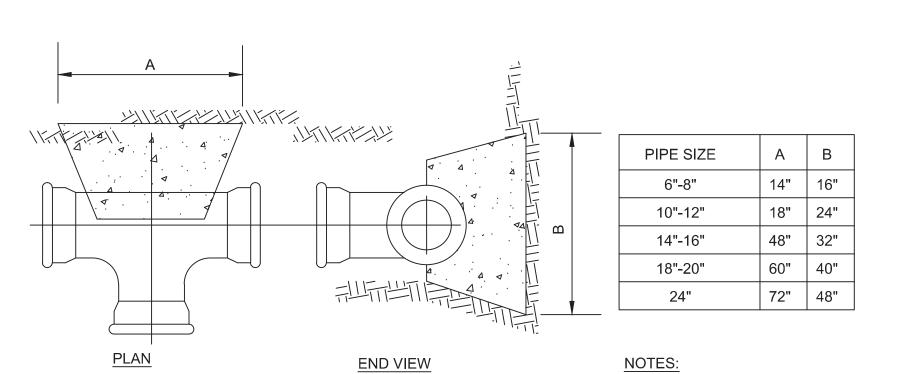

1. FOR MECHANICAL JOINT PIPE, TITON AND PVC PIPE TIE RODS MUST BE USED IN CONJUNCTION WITH CONCRETE THRUST BLOCKS FOR HYDRANTS, VALVES ON TEES, AND WHEREVER REQUIRED BY ENGINEER.

DETAIL OF TEE ANCHOR

CLIENT/OWNER

ENTERTAINMENT PROPERTIES TRUST 909 WALNUT, SUITE 200 KANSAS CITY, MO 64106 (816) 472-1700 (PHONE) (816) 472-5794 (FAX)

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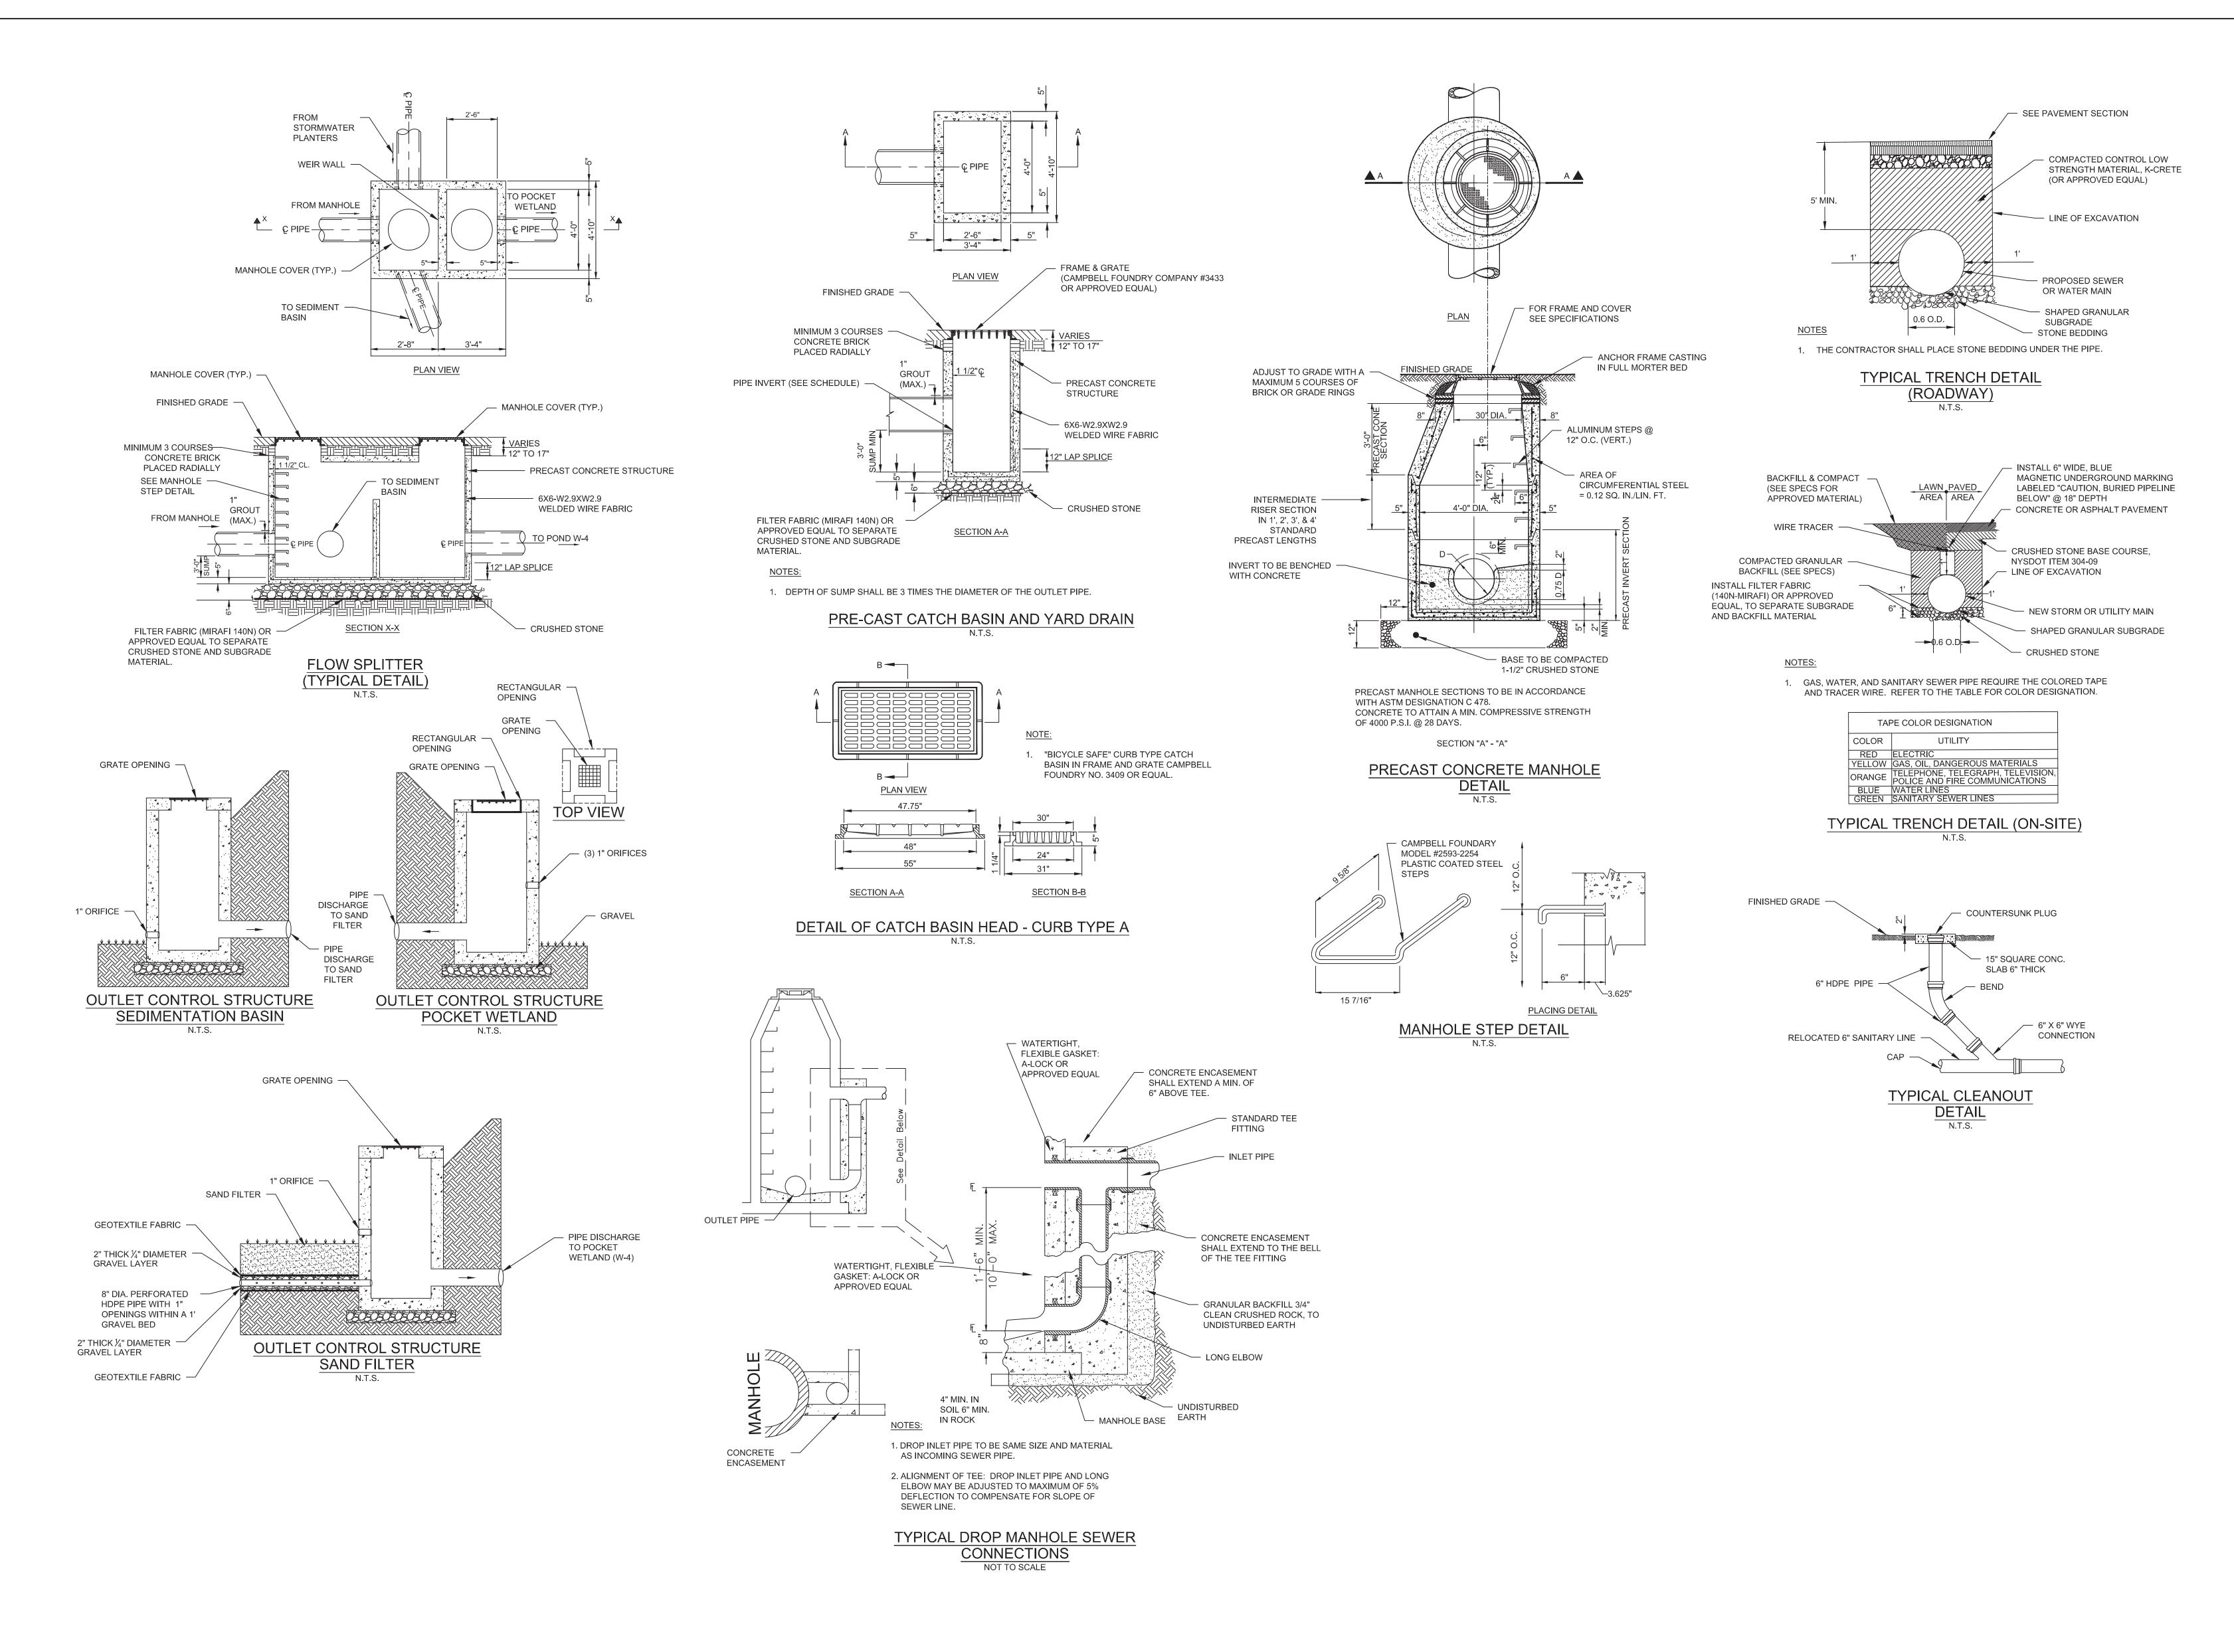
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DRAWN BY

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